
Conceptual Review Agenda

Schedule for 02/11/21

Meetings hosted via Zoom Web Conferencing

Thurso	lay, February 11, 2021			
Time	Project Name	Applicant Info	Project Description	
9:15	1235 N College Ave Commercial Addition CDR210010	Roger Hamacher 303-801-8440 rogerh.maverick@gmail.com	This is a request to construct a 4,750 square foot building addition at 1235 N College Ave (parcel # 9702109001). The project is located directly west of N College Avenue and 200 feet north of Hickory St. Access is taken from N College Ave to the east and Hickory St to the south. The property is within the Service Commercial (CS) zone district and is subject to a Major Amendment (MJA) process with an Administrative (Type 1) Review. PLEASE NOTE: A previous Conceptual Review for this proposal can be found under project number CDR200076.	Planner: Clark Mapes Engineer: Spencer Smith DRC: Tenae Beane
10:15	1034 W Vine Dr Wireless Telecommunication Facility CDR210011	Jeremy Underwood 623-271-4732 junderwood@tepgroup.net	This is a request to increase the height of an existing wireless telecommunication facility at 1034 W Vine Dr (parcel # 9702321001), formerly approved as "Verizon Wireless at 1052 W. Vine Dr". The proposed changes would increase the height of the existing facility from 70 feet to 95 feet. The site is directly north of W Vine Dr and directly east of N Shields St and is accessed via W Vine Dr. The site is within Limited Commercial (CL) zone district and is subject to a Major Amendment (MJA) process with an Administrative (Type 1) Review.	Planner: Ryan Mounce Engineer: Marc Virata DRC: Todd Sullivan
11:15	4000 Kechter Rd Single-Family Subdivision CDR210012	Mohsen Bagherian 719-321-0042 customvillasllc@aol.com	This is a request to develop a residential subdivision at 4000 Kechter Rd (parcel # 8604000014). The site is approximately 5 acres, and the proposal includes 11 half-acre lots. The existing home on the western edge of the property will remain in place and is not contemplated for redevelopment. Access to the subdivision would be from Strauss Cabin Rd directly to the east. The property is within the Urban Estate (UE) zone district and is subject to Administrative (Type 1) Review.	Planner: Kai Kleer Engineer: Dave Betley DRC: Brandy Bethurem Harras

1235 N College Ave Commercial Addition

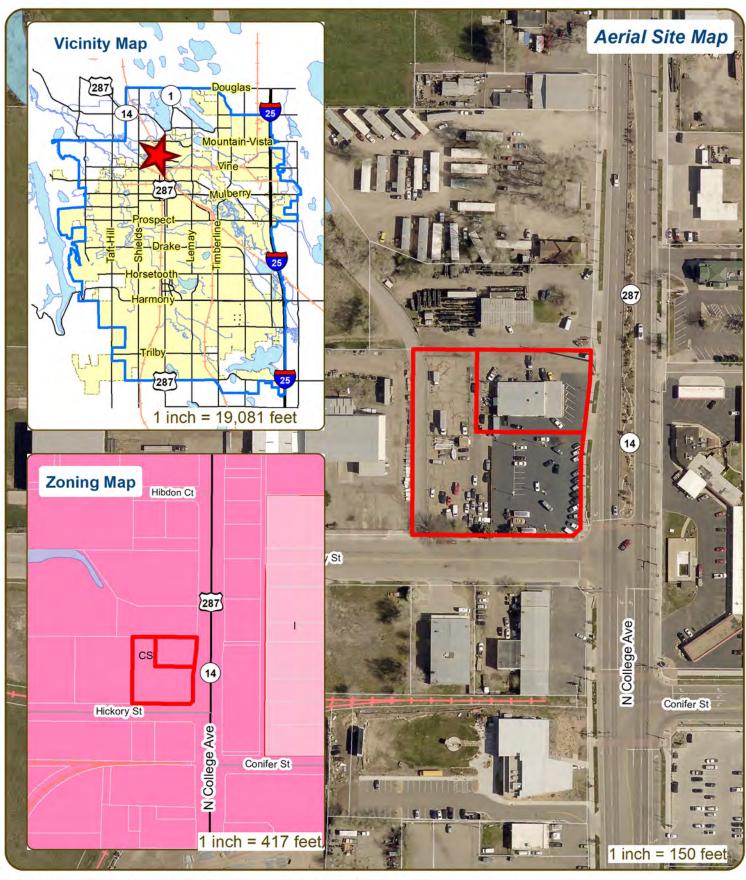

These map products and all underlying data are developed for use by the City of Fort Collins for its internal purposes only, and were not designed or intended for general use by members of the public. The City makes no representation or warranty as to its accuracy, timefiness, or completeness, and in particular; its accuracy in temberal general gen







Development Review Guide - STEP 2 of 8

CONCEPTUAL REVIEW: APPLICATION


General Information

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At Conceptual Review, you will meet with Staff from a number of City departments, such as Community Development and Neighborhood Services (Zoning, Current Planning, and Development Review Engineering), Light and Power, Stormwater, Water/Waste Water, Advance Planning (Long Range Planning and Transportation Planning) and Poudre Fire Authority. Comments are offered by staff to assist you in preparing the detailed components of the project application. There is no approval or denial of development proposals associated with Conceptual Review. At the meeting you will be presented with a letter from staff, summarizing comments on your proposal. *BOLDED ITEMS ARE REQUIRED* *The more info provided, the more detailed your comments from staff will be.*

BOLDED ITEMS ARE REQUIRED The more into provided, the more detailed your commentation of the more into provided, the more detailed your comments of the more into provided, the more detailed your comments of the more into provided, the more detailed your comments of the more into provided, the more into provided, the more into provided, the more detailed your comments of the more into provided, the more into provided, the more detailed your comments of the more into provided, the more detailed your comments of the more into provided, the more detailed your comments of the more into provided, the more detailed your comments of the more into provided, the more detailed your comments of the more detailed your comments of the more into provided, the more detailed your comments of the more detailed your comments o
Roger Hansiler (Owners Kep / Or. C.) Business Name (if applicable) auto Trends (owner Tobsite) Maverich Steel clue. (G.C.)
Business Name (if applicable) was been compared to the compare
Your Mailing Address 64905 Cost County Road 42 Byers, Co 80103
Phone Number 303-801-8440 Email Address 1000 F 4 (10: 10-00574)
Phone Number 303-801-8440 Email Address rogerh. marticlegmail.com Site Address or Description (parcel # if no address) 1235 N College are Fort Collins, Co 20524
Description of Proposal (attach additional sheets if necessary)
addition of 4,750 sq. St. P.E.M.B. Building
Proposed Use Shop Use Existing Use
Total Building Square Footage 4750 S.F. Number of Stories Lot Dimensions N/A
Age of any Existing Structures N/A
Info available on Larimer County's Website: http://www.co.larimer.co.us/assessor/query/search.cfm If any structures are 50+ years old, good quality, color photos of all sides of the structure are required for conceptual.
Is your property in a Flood Plain? Yes KNo If yes, then at what risk is it? NA
Info available on FC Maps: http://gisweb.fcgov.com/redirect/default.aspx?layerTheme=Floodplains.
Increase in Impervious Area 4,750 S.F. (Approximate amount of additional building, pavement, or etc. that will cover existing bare ground to be added to the site)
Suggested items for the Sketch Plan: Property location and boundaries, surrounding land uses, proposed use(s), existing and proposed improvements (buildings, landscaping, parking/drive areas, water treatment/detention, drainage), existing natural features (water bodies, wetlands, large trees, wildlife, canals, irrigation ditches), utility line locations (if known), photographs (helpful but not required). Things to consider when making a proposal: How does the site drain now? Will it change? If so, what will



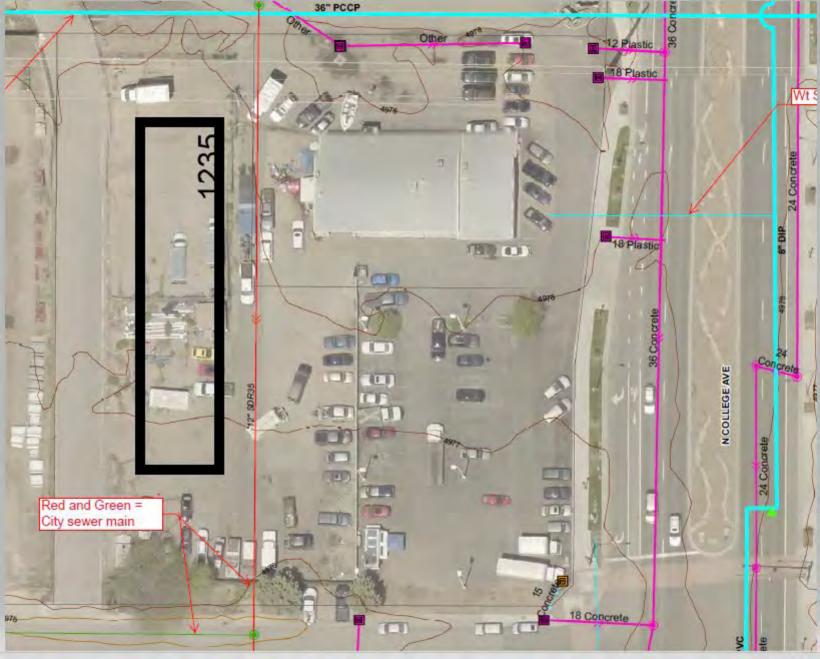

FCMaps



National Forest Fort Collins Greele Longment

Legend

- Parcels
- Growth Management Area
- Parks
- Schools
- Natural Areas
- City Limits

Notes R3S Holdings Sle. account #: R0010561

WGS_1984_Web_Mercator_Auxiliary_Sphere City of Fort Collins - GIS


This map is a user generated static output from the City of Fort Collins FCMaps Internet mapping site and is for reference only. Data layers that appear on this map may or may not be accurate, current, or otherwise reliable.












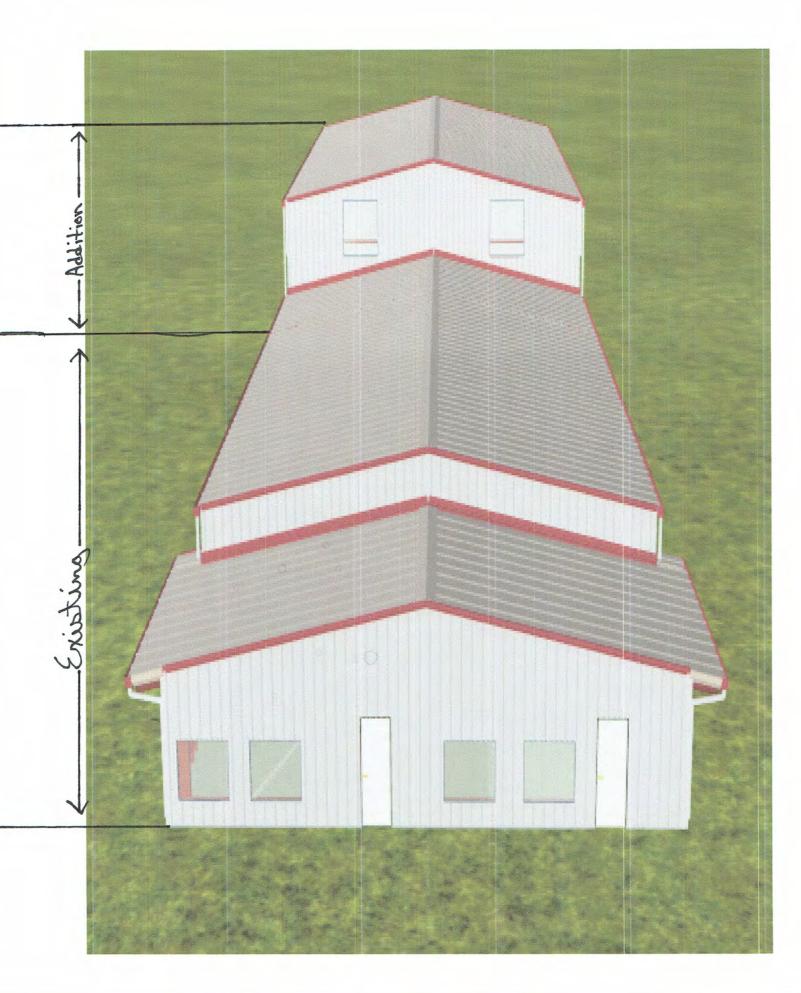





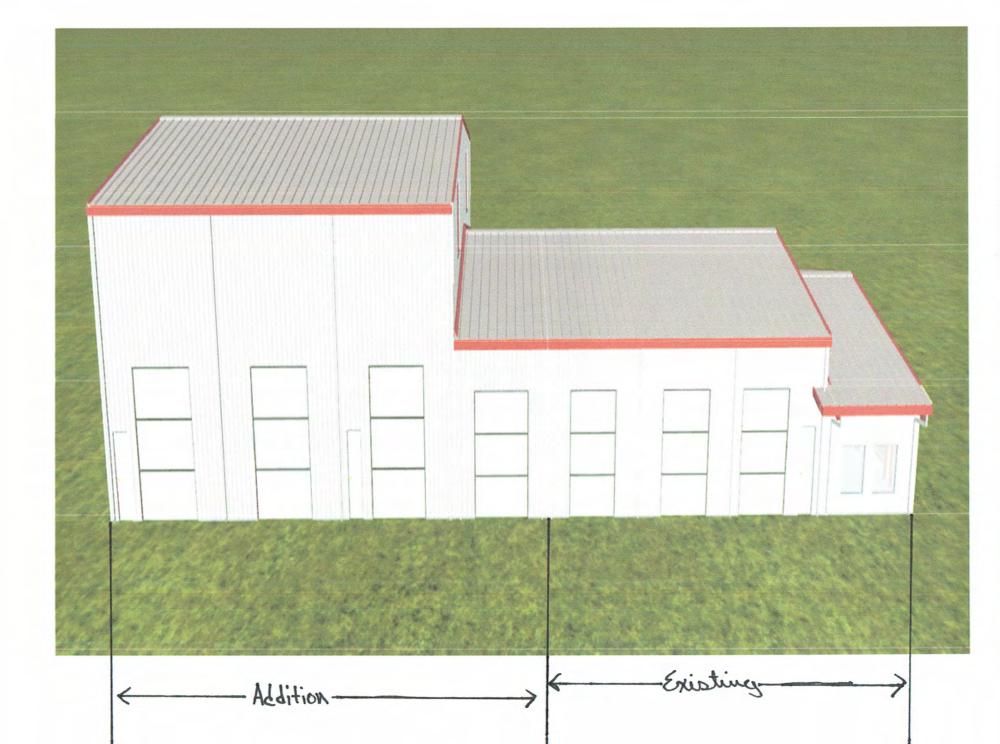

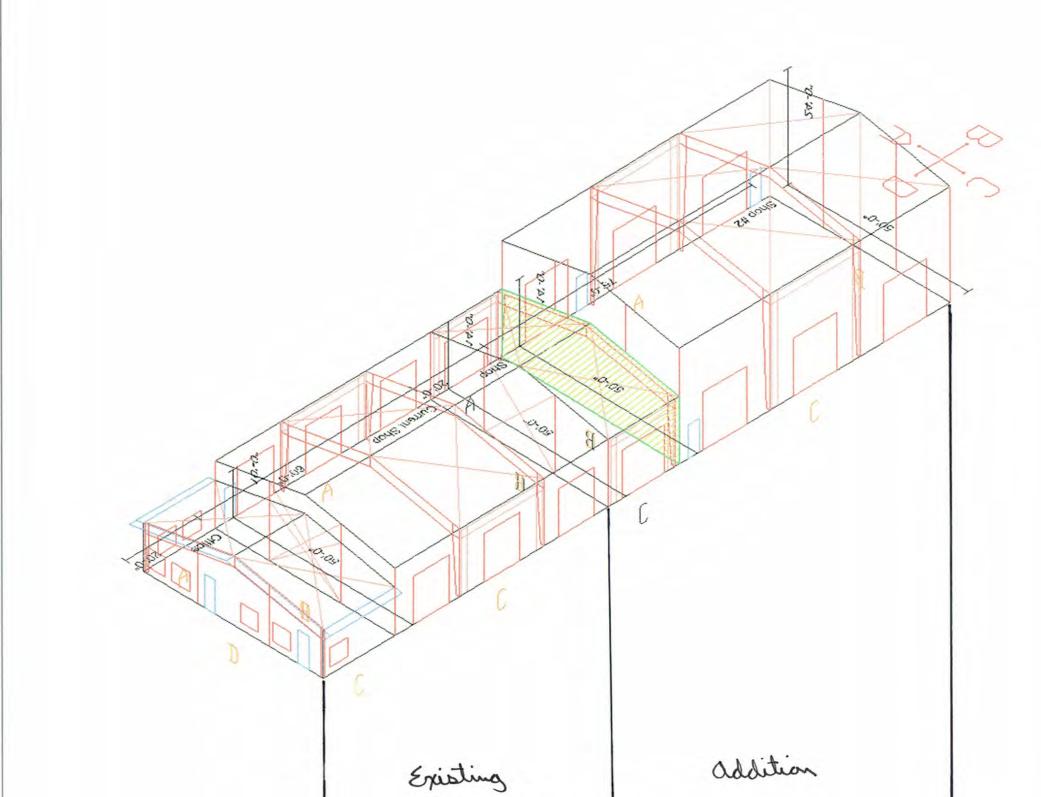


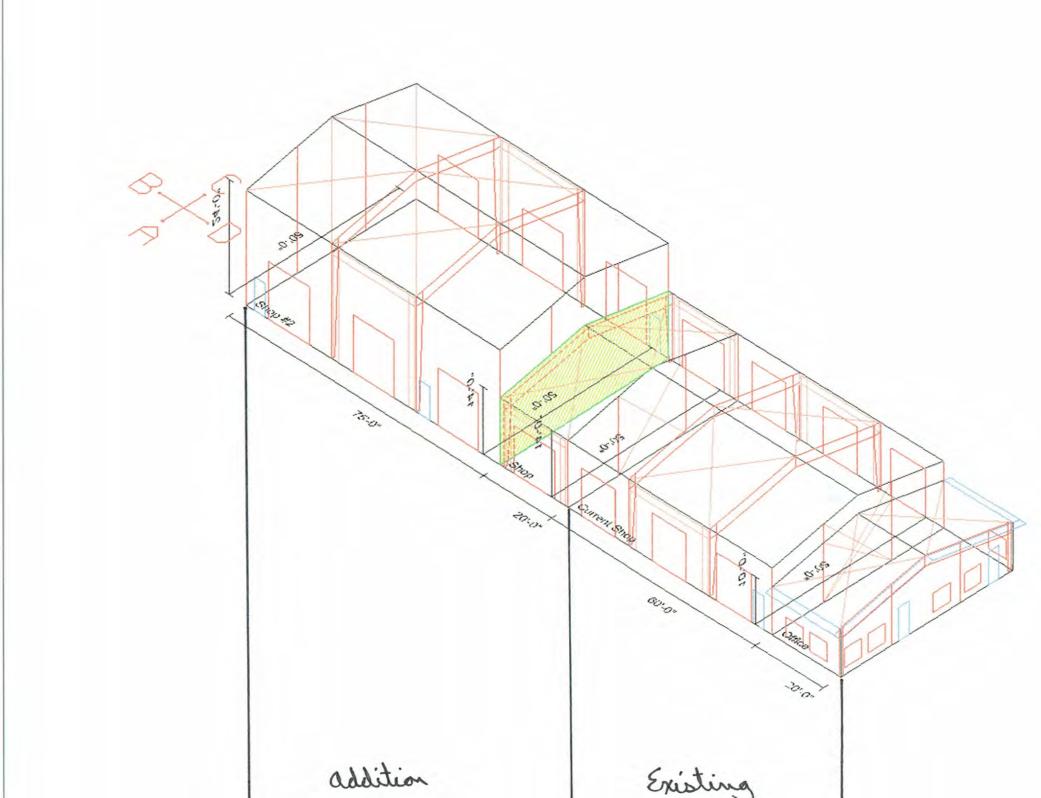

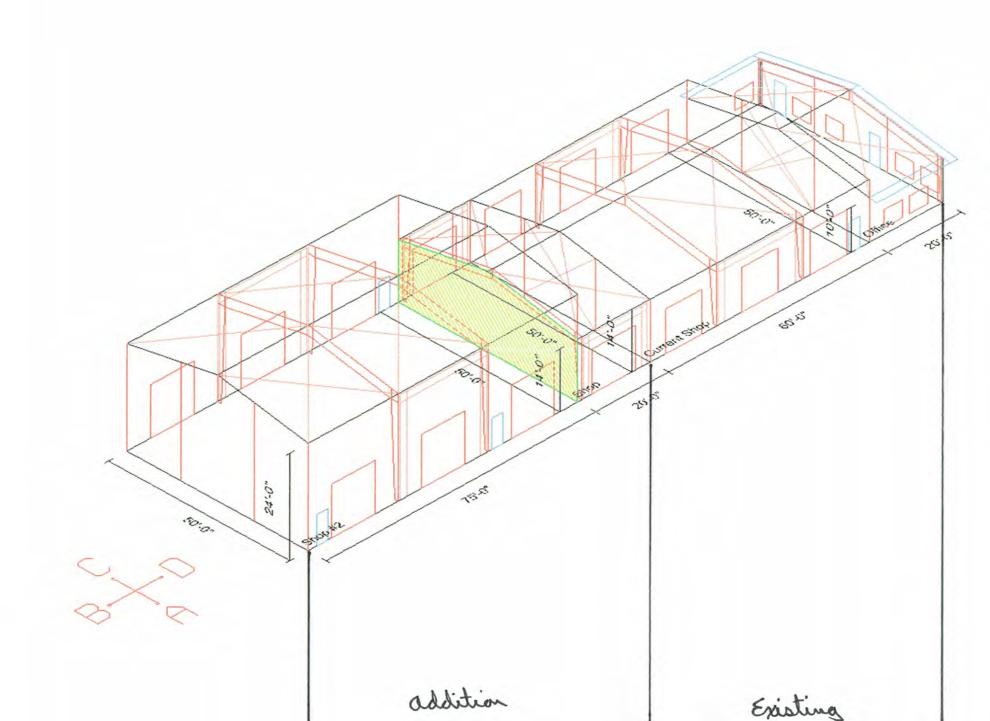

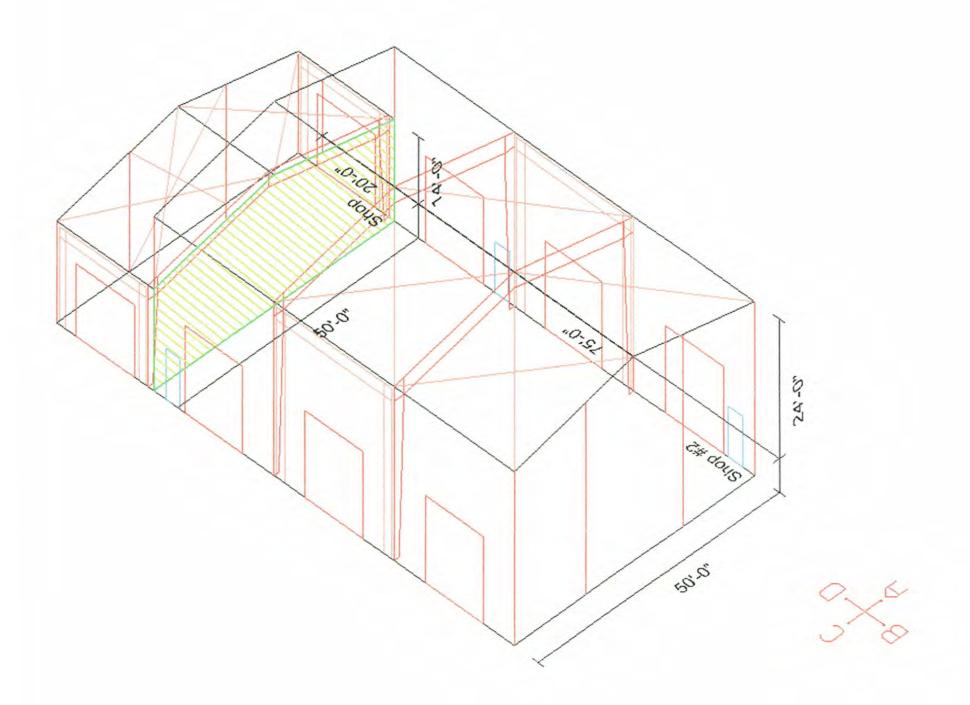


addition

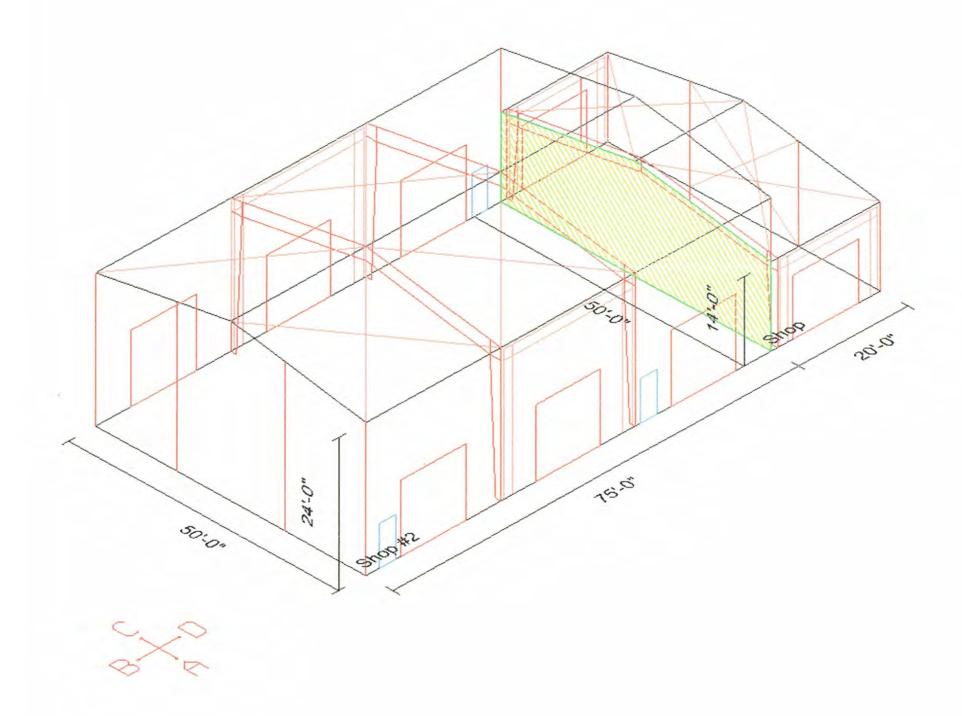

addition

1034 W Vine Dr Wireless Telecommunication Facility

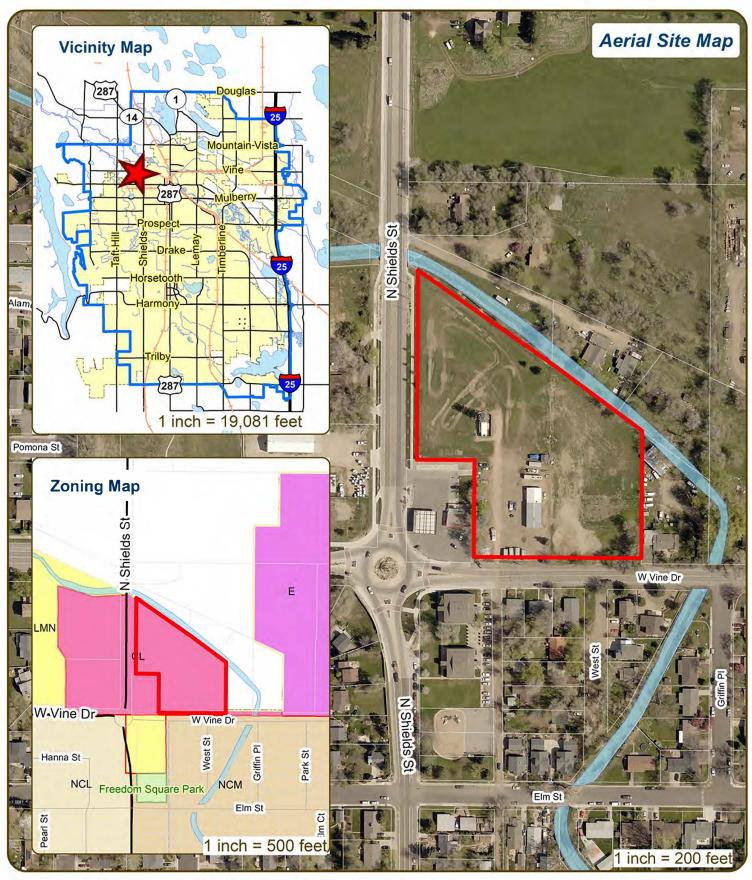

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Development Review Guide - STEP 2 of 8

CONCEPTUAL REVIEW: **APPLICATION**

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	D* *The more info provided, the more detailed your comments from staff will be.* ase identify whether Consultant or Owner, etc)
Business Name (if applicable)	
	Email Address
Site Address or Description (pare	eel # if no address)
Description of Proposal (attach a	dditional sheets if necessary)
Proposed Use	Existing Use
Total Building Square Footage	S.F. Number of Stories Lot Dimensions
Age of any Existing Structures _	
	Website: http://www.co.larimer.co.us/assessor/query/search.cfm good quality, color photos of all sides of the structure are required for conceptual.
Is your property in a Flood Plain	? □ Yes □ No If yes, then at what risk is it?
Info available on FC Maps: http://gi	sweb.fcgov.com/redirect/default.aspx?layerTheme=Floodplains.
Increase in Impervious Area(Approximate amount of additional	S.F. puilding, pavement, or etc. that will cover existing bare ground to be added to the site)
(buildings, landscaping, parking/driv	Plan: urrounding land uses, proposed use(s), existing and proposed improvements e areas, water treatment/detention, drainage), existing natural features (water bodies, s, irrigation ditches), utility line locations (if known), photographs (helpful but not

required). Things to consider when making a proposal: How does the site drain now? Will it change? If so, what will change?




161 INVERNESS DR W, 2ND FLOOR ENGLEWOOD, CO 80112

AT&T SITE NAME: COL03271 AT&T SITE ID: COL03271 AT&T PACE NUMBER: MRUTH042446 AT&T FA CODE: 15312472 **NSB - MONOPINE** LTE 1C/2C/3C/4C/5G NR 1SR/5C



ATC SITE NAME: FAT_TIRE CO ATC SITE NUMBER: 420055 SITE ADDRESS: 1052 W VINE DR FORT COLLINS, CO. 80521 (LARIMER COUNTY)

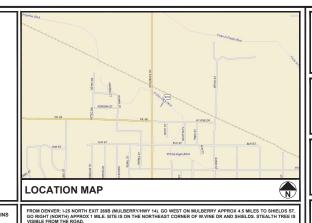

161 INVERNESS DR W, 2ND FLOOR ENGLEWOOD, CO 80112



AMERICAN TOWER 19100 VON KARMAN AVE SUITE 200 IRVINE, CA 92612



AT&T SITE ID: COL03271 AT&T FA CODE: 15312472 AT&T PACE #: MRUTH042446 ATC #: 420055 FAT_TIRE CO

1052 W VINE DR FORT COLLINS, CO 80521 (LARIMER COUNTY)

EXISTING 70'-0" MONOPINE TOWER NSB - LTE - 1C/2C/3C/4C/ 5G NR 1SR/5C

П			ISSU	ED FOR:	
Ш	REV	DATE	DRWN	DESCRIPTION	QA
П	Α	12-01-20	RRG	PRELIMINARY	EGG
П					
П					
П					
П					



TITLE SHEET

SHEET NUMBER:

TEP#:

REVISION:

N 40° 35' 49.59" (40.59711°) LONGITUDE W 105° 5' 42.07" (-105.09502°)

*GROUND ELEV. (AMSL) = 5,010'±

*INFORMATION PROVIDED BY ATC

ATC SITE NAME:

ATC SITE NUMBER

ALL WORK AND MATERIALS SHALL BE PERFORMED AND INSTALLED IN ACCORDANC WITH THE CURRENT EDITIONS OF THE FOLLOWING CODES AS ADOPTED BY THE LOCA GOVERNING AUTHORITES, NOTHINIG IN THESE PLANS IS TO BE CONSTRUED TO PERMI WORK NOT CONFORMING TO THE LATEST EDITIONS OF THE FOLLOWING:

1. INTERNATIONAL BUILDING CODE

2. INTERNATIONAL CODE COUNCIL
3. ANSI/TIA/EIA-222-H

4. NATIONAL ELECTRIC CODE (2020 EDITION)
5. LOCAL BUILDING CODE
6. CITY/COUNTY ORDINANCES

CODE COMPLIANCE PROJECT DESCRIPTION: COLLOCATION

AT&T SITE NAME: COL03271 AT&T SITE ID: COL 03271 FA: 15312472 PACE NUMBER: MRUTH042446

TOWER COORDINATES

FAT_TIRE CO

TOWER TYPE: 70' MONOPINE LARIMER COUNTY JURISDICTION: LEASE AREA: 198 SQ FT CURRENT ZONING: FA

PROJECT INFORMATION

420055

SITE CONSTRUCTION MANAGER:	SHEET:	DESCRIPTION:	REV
NAME: AT&T	T-1	TITLE SHEET	Α
ADDRESS: 161 INVERNESS DR W, 2ND FLOOR CITY, STATE, ZIP: ENGLEWOOD, CO 80112 CONTACT: RFID POST	T-2	GENERAL NOTES	Α
PHONE: (720) 838-4228	S-1	SITE SURVEY	Α
	C-1	COMPOUND DETAIL	А
SITE APPLICANT: NAME: AT&T	C-2	EQUIPMENT & ANTENNA LAYOUTS	Α
ADDRESS: 4393 S RIVERBOAT RD, 4TH FLOOR CITY, STATE, ZIP: SALT LAKE CITY, UT 84123	C-3	EXISTING AND FINAL ELEVATIONS	Α
CONTACT: JAN ROBINETTE PHONE: (801) 201-4173	C-4	EQUIPMENT DETAILS	А
	C-5	EQUIPMENT DETAILS	А
CIVIL ENGINEER: NAME: TOWER ENGINEERING	C-6	WIC SHELTER DETAILS	Α
PROFESSIONALS ADDRESS: 326 TRYON ROAD	C-7	GENERATOR DETAILS	Α
CITY, STATE, ZIP: RALEIGH, NC 27603 CONTACT: GRAHAM M. ANDRES, P.E. PHONE: (919) 661-6351	C-8	FOUNDATION DETAILS	А
PHONE: (919) 661-6551	E-1	ELECTRICAL PANEL & GROUNDING PLANS	Α
ELECTRICAL ENGINEER:	E-2	ONE-LINE DIAGRAM	Α
NAME: TOWER ENGINEERING PROFESSIONALS	E-3	DC SYSTEM DETAILS	А
ADDRESS: 326 TRYON ROAD CITY, STATE, ZIP: RALEIGH, NC 27603 CONTACT: MARK S QUAKENBUSH P.F.	G-1	GROUNDING DETAILS	Α
CONTACT: MARK S. QUAKENBUSH, P.E. PHONE: (919) 661-6351	G-2	GROUNDING DETAILS	Α
PROPERTY OWNER: NAME: VINE STREET STORAGE LLC ADDRESS: 1035 W VINE DR CITY, STATE, ZIP: FORT COLLINS, CO 80521			
PROJECT TEAM	SHEET INDE	<u>.</u> X	

POWER COMPANY: CITY OF FORT COLLINS LIGHT AND POWER CONTACT: CUSTOMER SERVICE PHONE: (970) 221-6700

METER # NEAR SITE: 15 840 094

TELEPHONE COMPANY OWEST CORPORATION CONTACT: UNKNOWN (800) 244-1111

(970) 482-5810

UNKNOWN

UTILITY INFORMATION DESIGN PACKAGE BASED ON RF DATA SHEET

RFDS NAME: COL03271
REVISION: V1.00
ISSUED: 09/21/2020 5:32:10 P.M.
DATE UPDATED: 10/14/2020 11:22:57 A.M. NUMBER OF SECTORS: 3 NUMBER OF ANTENNAS: 5 NUMBER OF TIMAS: 0 NUMBER OF RRHs: 12 NUMBER OF RIBERIO COUIDS: 2 NUMBER OF DC SOUIDS: 0 NUMBER OF DC SOUIDS: 0 NUMBER OF DC TRUNK CABLES: 2 NUMBER OF DC TRUNK CABLES: 4 IUMBER OF RF CABLES: 0

PHONE # NEAR SITE:

PEDESTAL # NEAR SITE:

RFDS DATA

INSTALL (6) ANTENNAS INSTALL (12) RRHs INSTALL (2) SQUIDS INSTALL (2) FIBER TRUNKS INSTALL (4) DC TRUNKS INSTALL (4) C TRUNKS

ROUND SCOPE OF WORK:

INSTALL (1) W.I.C. SHELTER PAD INSTALL (1) W.L.C. SHELTER PA INSTALL (1) W.L.C SHELTER INSTALL (1) GENERATOR INSTALL (1) H-FRAME

INSTALL METER INSTALL DISCONNECT INSTALL FIBER BOX

NSB - MONOPINE LTE - 1C/2C/3C/4C/5G NR 1SR/5C

SCOPE OF WORK

CONTRACTOR SHALL VERIFY ALL PLANS AND EXISTING DIMENSIONS AND CONDITIONS ON THE JOB SITE AND SHALL IMMEDIATELY NOTIFY THE ARCHITECT/ENGINEER IN WRITING OF ANY DISCREPANCIES BEFORE PROCEEDING WITH THE WORK OR BE RESPONSIBLE FOR SAME.

THE FACILITY IS UNMANNED AND NOT FOR VIUMAN HABITATION. A TECHNICIAN WILL VISIT THE SITE AS REQUIRED FOR ROUTINE MAINTENANCE. THE PROJECT WILL NOT RESULT IN ANY SIGNIFICANT DISTURBANCE OF BEFFET ON DRAINAGE. NO SANITARY SEWER SERVICE, POTABLE WATER, OR TRASH DISPOSAL IS REQUIRED AND NO COMMERCIAL SIGNAGE IS PROPOSED.

JURISDICTIONAL APPROVAL

DRIVING DIRECTIONS

GENERAL NOTES

GENERAL CONSTRUCTION NOTES:

- OWNER FURNISHED MATERIALS, AT&T "THE COMPANY" WILL PROVIDE AND THE
 - BTS EQUIPMENT FRAME (PLATFORM) AND ICEBRIDGE SHELTER (GROUND BUILDICO-LOCATE ONLY)

 - BUILDICO-LOCATE ONLY)

 ACTIELCO INTERNACE BOX (PPC)
 ICE BRIDGE (CABLE TRAY WITH COVER) (GROUND BUILDICO-LOCATE ONLY,
 TOWERS, MONDOPLES
 TOWER LIGHTING

 - GENERATORS & LIQUID PROPANE TANK
 ANTENNA STANDARD BRACKETS, FRAMES AND PIPES FOR MOUNTING
- ANTENNAS (INSTALLED BY OTHERS)
- TRANSMISSION LINE TRANSMISSION LINE JUMPERS TRANSMISSION LINE CONNEC TORS WITH WEATHERPROOFING KITS
- TRANSMISSION LINE GROUND KITS
- HANGERS
- O. BTS EQUIPMEN
- THE CONTRACTOR IS RESPONSIBLE TO PROVIDE ALL OTHER MATERIALS FOR THE COMPLETE INSTALLATION OF THE SITE INCLUDING, BUT NOT LIMITED TO, SUCH MATERIALS AS FENCING. STRUCTURAL STEEL SUPPORTING SUB-FRAME FOR PLATFORM, ROOFING LABOR AND MATERIALS, GROUNDING RINGS, GROUNDING WIRES, COPPER-CLAD OR XIT CHEMICAL GROUND ROD(S), BUSS BARS, TRANSFORMERS AND DISCONNECT SWITCHES WHERE APPLICABLE. TEMPORARY TRANSFORMERS AND DISCONNECT SWITCHES WHERE APPLICABLE, TEMPORARY LELECTRICAL POWER, COMBUL STATE, CAMPOLING TOTAL, CAMPOLING STATE, CAMPOLING STATE, CAMPOLING STATE AND RUBBER MATTIMG, REBAR, CONCRETE CAISSONS, PADS AND REQUIRED TO COMPLETE THE JOB ACCORDING TO THE DRAWINGS AND SPECIFICATIONS. IT IS THE POSITION OF ATAT TO APPLY FOR PERMITTING AND CONTRACTOR RESPONSING FOR PICKILP AND PAYMENT OF REQUIRED PERMITS.
- ALL WORK SHALL CONFORM TO ALL CURRENT APPLICABLE FEDERAL, STATE, AND LOCAL CODES, INCLUDING ANS//EIA/TIA-222, AND COMPLY WITH ATC CONSTRUCTION SPECIFICATIONS.
- CONTRACTOR SHALL CONTACT LOCAL 811 FOR IDENTIFICATION OF UNDERGROUND UTILITIES PRIOR TO START OF CONSTRUCTION.
- CONTRACTOR SHALL BE RESPONSIBLE FOR COORDINATING ALL REQUIRED INSERTIONS
- NSIONS TO, OF, AND ON EXISTING BUILDINGS, DRAINAGE STRUCTURES, IMPROVEMENTS SHALL BE VERIFIED IN FIELD BY CONTRACTOR WITH ALL INCIES REPORTED TO THE ENGINEER.
- DO NOT CHANGE SIZE OR SPACING OF STRUCTURAL ELEMENTS.
- DETAILS SHOWN ARE TYPICAL; SIMILAR DETAILS APPLY TO SIMILAR CONDITIONS
- THESE DRAWINGS DO NOT INCLUDE NECESSARY COMPONENTS FOR CONSTRUCTION SAFETY WHICH SHALL BE THE SOLE RESPONSIBILITY OF THE CONTRACTOR.
- CONTRACTOR SHALL BRACE STRUCTURES UNTIL ALL STRUCTURAL ELEMENTS NEEDED FOR STABILITY ARE INSTALLED. THESE ELEMENTS ARE AS FOLLOWS: LATERAL BRACING, ANCHOR BOLTS, ETC.
- CONTRACTOR SHALL DETERMINE EXACT LOCATION OF EXISTING UTILITIES, GROUNDS DRAINS, DRAIN PIPES, VENTS, ETC. BEFORE COMMENCING WORK
- INCORRECTLY FABRICATED, DAMAGED, OR OTHERWISE MISFITTING OR NONCONFORMING MATERIALS OR CONDITIONS SHALL BE REPORTED TO THE ATAT REP PRIOR TO REMEDIAL OR CORRECTIVE ACTION. ANY SUCH REMEDIAL ACTION SHALL REQUIRE WRITTEN APPROVAL BY THE ATAT REP PRIOR TO PROCEEDING.
- EACH CONTRACTOR SHALL COOPERATE WITH THE AT&T REP, AND COORDINATE HIS WORK WITH THE WORK OF CTHERS
- CONTRACTOR SHALL REPAIR ANY DAMAGE CAUSED BY CONSTRUCTION OF THIS PROJECT TO MATCH EXISTING PRE-CONSTRUCTION CONDITION: SATISFACTION OF THE AT&T CONSTRUCTION MANAGER.
- ALL CABLE/CONDUIT ENTRY/EXIT PORTS SHALL BE WEATHERPROOFED DURING INSTALLATION USING A SILICONE SEALANT.
- WHERE EXISTING CONDITIONS DO NOT MATCH THOSE SHOWN IN THIS PLAN SET, CONTRACTOR SHALL NOTIFY THE AT&T REP AND ENGINEER OF RECORD IMMEDIATELY.
- CONTRACTOR SHALL ENSURE ALL SUBCONTRACTORS ARE PROVIDED WITH A COMPLETE AND CURRENT SET OF DRAWINGS AND SPECIFICATIONS FOR THIS
- CONTRACTOR SHALL REMOVE ALL RUBBISH AND DEBRIS FROM THE SITE AT THE END OF EACH DAY.
- CONTRACTOR SHALL COORDINATE WORK SCHEDULE WITH AMERICAN TOWER CORPORATION (ATC) AND TAKE PRECAUTIONS TO MINIMIZE IMPACT AND DISRUPTION OF OTHER OCCUPANTS OF THE FACILITY.
- 20. CONTRACTOR SHALL FURNISH ##### (ATC) WITH A PDF MARKED UP AS-BUILT SET OF DRAWINGS UPON COMPLETION OF WORK. ###### AND AMERICAN TOWER CORPORATION
- PRIOR TO SUBMISSION OF BID, CONTRACTOR SHALL COORDINATE WITH ATAT REP TO DETERMINE WHAT, IF ANY, ITEMS WILL BE PROVIDED. ALL TIEMS NOT PROVIDED SHALL BE PROVIDED AND INSTALLED BY THE CONTRACTOR. CONTRACTOR WILL INSTALL ALL TIEMS PROVIDED.
- PRIOR TO SUBMISSION OF BID, CONTRACTOR SHALL COORDINATE WITH AT&T REP TO DETERMINE IF ANY PERMITS WILL BE OBTAINED BY CONTRACTOR. ALL REQUIRED PERMITS NOT OBTAINED BY AT&T MUST BE OBTAINED, AND PAID FOR, BY THE
- 23. CONTRACTOR SHALL INSTALL ALL SITE SIGNAGE IN ACCORDANCE WITH AT&T

- 24. CONTRACTOR SHALL SUBMIT ALL SHOP DRAWINGS TO AT&T FOR REVIEW AND APPROVAL PRIOR TO FABRICATION.
- ALL EQUIPMENT SHALL BE INSTALLED ACCORDING TO MANUFACTURER'S SPECIFICATIONS AND LOCATED ACCORDING TO AT&T SPECIFICATIONS, AND AS SHOWN IN THESE PLANS.
- 26. THE CONTRACTOR SHALL SUPERVISE AND DIRECT THE PROJECT DESCRIBED HEREIN. THE CONTRACTOR SHALL BE SOLELY RESPONSIBLE FOR ALL THE CONSTRUCTION MEANS, METHODS, TECHNIQUES, SEQUENCES AND PROCEDURES AND FOR COORDINATING ALL PORTIONS OF THE WORK UNDER THE CONTRACT.
- 27. CONTRACTOR SHALL NOTIFY AT&T REP A MINIMUM OF 48 HOURS IN ADVANCE OF POURING CONCRETE OR BACKFILLING ANY UNDERGROUND UTILITIES, FOUNDATIONS O SEALING ANY WALL, FLOOR OR ROOF PENETRATIONS FOR ENGINEERING REVIEW AND
- 28. CONTRACTOR SHALL BE RESPONSIBLE FOR SITE SAFETY INCLUDING COMPLIANCE WITH ALL APPLICABLE OSHA STANDARDS AND RECOMMENDATIONS AND SHALL PROVIDE ALL NECESSARY SAFETY DEVICES INCLUDING PER AND PPM AND CONTRICTION DEVICES SUCH AS WELDING AND FIRE PREVENTION, TEMPORARY SHORING, SCAPFOLING, TRENCH DOXESS LOPHNE, BARRIERS, ETC.
- 29. THE CONTRACTOR SHALL PROTECT AT HIS OWN EXPENSE, ALL EXISTING FACILITIES AND SUCH OF HIS NEW WORK LIABLE TO INJURY DURING THE CONSTRUCTION PERIOD.
 ANY DAMAGE CAUSED BY NEGLECT ON THE PART OF THIS CONTRACTOR OR HIS
 REPRESENTATIVES. OR BY THE ELEMENTS DUE TO NEGLECT ON THE PART OF THIS CONTRACTOR OR BY THE ELEMENTS DUE TO NEGLECT ON THE PART OF THIS CONTRACTOR OR HIS REPRESENTATIVES, EITHER TO THE EXISTING WORK, OR TO HIS WORK OF ANY OTHER CONTRACTOR, SHALL BE REPAIRED AT HIS EXPENSE TO THE OWNER'S SATISFACTION
- ALL WORK SHALL BE INSTALLED IN A FIRST CLASS, NEAT AND WORKMANLIKE NNER BY MECHANICS SKILLED IN THE TRADE INVOLVED. THE QUALITY OF RKMANSHIP SHALL BE SUBJECT TO THE APPROVAL OF THE ATAT REP. ANY WORK FOUND BY THE ATTA TREP TO BE OF INFERIOR QUALITY ANDIOR WORKMANSHIP SHALL BE REPLACED AND/OR REWORKED AT CONTRACTOR EXPENSE UNTIL APPROVAL IS QUETAMED.
- 31. IN ORDER TO ESTABLISH STANDARDS OF QUALITY AND PERFORMANCE, ALL TYPES OF MATERIALS LISTED HEREINAFTER BY MANUFACTURER'S NAMES ANDIOR MANUFACTURER'S CATALOG NUMBER SHALL BE PROVIDED BY THESE MANUFACTURERS AS SPECIFIED.
- 32. ATAT FURNISHED EQUIPMENT SHALL BE PICKED-UP AT THE ATAT WAREHOUSE, NO LATER THAN 48HR AFTER BEING NOTHED INSURED, STORED, UNCRATE, PROTECTED AND INSTALLED BY THE CONTRACTOR WITH ALL APPURENANCES REQUIRED TO PLACE THE COUNTERING TO PLACE THE COUNTRACTOR SHALL BE RESPONSIBLE FOR THE EQUIPMENT AFTER PICKING TUP.
- 33. AT&T OR HIS ARCHITECT/ENGINEER RESERVES THE RIGHT TO REJECT ANY EQUIPMENT OR MATERIALS WHICH, IN HIS OWN OPINION ARE NOT IN COMPLIANCE WITH THE CONTRACT DOCUMENTS, EITHER BEFORE OR A FITER INSTALLATION AND THE EQUIPMENT SHALL BE REPLACED WITH EQUIPMENT CONFORMING TO THE REQUIREMENTS OF THE CONTRACTOR OF ANY OCS TO ATAT OR THEIR

STRUCTURAL STEEL NOTES:

- STRUCTURAL STEEL SHALL CONFORM TO THE LATEST EDITION OF THE AISC "SPECIFICATION FOR THE DESIGN, FABRICATION AND ERECTION OF STRUCTURAL STEEL EOR BILLI DAIGS."
- STRUCTURAL STEEL ROLLED SHAPES, PLATES AND BARS SHALL CONFORM TO THE FOIL OWING ASTM DESIGNATIONS:
- A. ASTM A-572, GRADE 50 ALL W SHAPES, UNLESS NOTED OR A992 OTHERWISE
- ASTM A-36 ALL OTHER ROLLED SHAPES, PLATES AND BARS UNLESS NOTED
- C. ASTM A-500, GRADE B HSS SECTION (SQUARE, RECTANGULAR, AND ROUND)
- D. ASTM A-325, TYPE SC OR N ALL BOLTS FOR CONNECTING STRUCTURAL
- E.ASTM F-1554 07 ALL ANCHOR BOLTS, UNLESS NOTED OTHERWISE
- 4. ALL FIELD CUT SUBTACES, FIELD DRILLED HOLES AND GROUND SURFACES WHERE EXISTING PAINT OR GALVANIZATION REMOVAL WAS REQUIRED SHALL BE REPAIRED WITH (2) BRUSHED COATS OF ZRC GALVILITE COLD GALVANIZING COMPOUND PER ASTM A780 AND MANUFACTURER'S RECOMMENDATIONS.
- DO NOT DRILL HOLES THROUGH STRUCTURAL STEEL MEMBERS EXCEPT AS SHOWN AND DETAILED ON STRUCTURAL DRAWINGS.
- 6 CONNECTIONS
- A. ALL WELDING TO BE PERFORMED BY AWS CERTIFIED WELDERS AND CONDUCTED IN ACCORDANCE WITH THE LATEST EDITION OF THE AWS WELDING CODE D1.1.
- B. ALL WELDS SHALL BE INSPECTED VISUALLY, 25% OF WELDS SHALL BE INSPECTED WITH DVE PENETRANT OR MAGNETIC PARTICLE TO MEET THE ACCEPTANCE CRITERIA OF AWS D1.1. REPAIR ALL WELDS AS NECESSARY.
- D. IT IS THE CONTRACTORS RESPONSIBILITY TO PROVIDE BURNING/WELDING PERMITS AS REQUIRED BY LOCAL GOVERNING AUTHORITY AND IF REQUIRED SHALL HAVE FIRE DEPARTMENT DETAIL FOR ANY WELDING ACTIVITY.
- E. ALL ELECTRODES TO BE LOW HYDROGEN, MATCHING FILLER METAL, PER AWS D1.1, UNLESS NOTED OTHERWISF
- F. MINIMUM WELD SIZE TO BE 0.1875 INCH FILLET WELDS, UNLESS NOTED OTHERWISE.

- PRIOR TO FIELD WELDING GALVANIZING MATERIAL, CONTRACTOR SHALL GRIND OFF ALVANIZING ½" BEYOND ALL FIELD WELD SURFACES. AFTER WELD AND WELD SPECTION IS COMPLETE, REPAIR ALL GROUND AND WELDED SURFACES WITH ZRC GALVILITE COLD GALVANIZING COMPOUND PER ASTM A780 AND MANUFACTURERS
- THE CONTRACTOR SHALL PROVIDE ADEQUATE SHORING AND/OR BRACING WHERE QUIRED DURING CONSTRUCTION UNTIL ALL CONNECTIONS ARE COMPLETE.
- I. ANY FIELD CHANGES OR SUBSTITUTIONS SHALL HAVE PRIOR APPROVAL FROM THE ENGINEER, AND AT&T PROJECT MANAGER IN WRITING

SPECIAL CONSTRUCTION ANTENNA INSTALLATION NOTES:

- 1. WORK INCLUDED:
- A. ANTENNA AND COAXIAL CABLES ARE FURNISHED BY AT&T UNDER A SEPARATE CONTRACT. THE CONTRACTOR SHALL ASSIST ANTENNA INSTALLATION CONTRACTOR IN TERMS OO COORDINATION AND SITE ACCESS. ERECTION SUBCONTRACTOR SHALL BE RESPONSIBLE FOR THE PROTECTION OF PERSONNEL AND
- B. INSTALL ANTENNA AS INDICATE ON DRAWINGS AND AT&T SPECIFICATIONS.
- C. INSTALL GALVANIZED STEEL ANTENNA MOUNTS AS INDICATED ON DRAWINGS
- INSTALL FURNISHED GALVANIZED STEEL OR ALUMINUM WAVEGUIDE AND PROVIDE INTOUT OF THAT TEST.
- E. CONTACTOR SHALL PROVIDE FOUR () SETS OF SWEEP TESTS USING AMERICAN PROVIDE FOR THE RESIDENCE RETWORK ANALYZES, DUBBIT FREGUENCY DOMAIN REFLECTOMETER/FIDS, TESTS RESULTS TO THE PROJECT MANAGER. SWEEP TESTS REFLECTOR FERROMETER FOR THINMINGH FILE TISTS OR RECOMMENDED FOR THE PROVIDE THE RESIDENCE FOR THE RESIDENCE F

- 2. ALL EXTERIOR #8 GREED GROUND WIRE "DAISY CHAIN" CONNECTIONS ARE TO BE WEATHER SEALED WITH RPS CONNECTORS/SPLICE WEATHERPROOFING KIT #221213 OR EQUIAL.
- 3. ALL COAXIAL CABLE GROUNDING KITS ARE TO BE INSTALLED ON STRAIGHT RUNS OF COAXIAL CABLE (NOT WITHIN BENDS)

CONCRETE AND REINFORCING STEEL NOTES:

- DESIGN AND CONSTRUCTION OF ALL CONCRETE ELEMENTS SHALL CONFORM TO THE LATEST EDITIONS OF ALL APPLICABLE CODES INCLUDING: ACI 301 "SPECIFICATIONS FOR STRUCTURAL CONCRETE FOR BUILDINGS", ACI 17" "SPECIFICATIONS FOR TOLERANCES FOR CONCRETE CONSTRUCTION AND MATERIALS", AND ACI 318 "BUILDING CODE REQUIREMENTS FOR REINFORCED CONCRETE".
- 2. MIX DESIGN SHALL BE APPROVED BY AT&T REP PRIOR TO PLACING CONCRETE
- 2 CONCRETE SHALL BE NORMAL WEIGHT 6 % AIR ENTRAINED (A), 4 6%) WITH A SLLIMD RANGE OF 3-6" AND HAVE A MINIMUM 28-DAY COMPRESSIVE STRENGTH OF 4000 PT UNLESS OTHERWISE NOTED.
- 4 THE FOLLOWING MATERIALS SHALL BE USED:
 - PORTLAND CEMENT:
 REINFORCEMENT:
 REINFORCEMENT BARS: ASTM C150, TYPE 2 ASTM A185, PLAIN STEEL WELDED WIRE FABRIC ASTM A615, GRADE 60, DEFORMED
 - NORMAL WEIGHT AGGREGATE: ASTM C33 WATER-ASTM C 94/C 94M WELDED WIRE FABRIC:
 - ADMIXTURES:
 -WATER-REDUCING AGENT: ASTM C 494/C 494M, TYPE A -AIR-ENTERING AGENT: ASTM C 260/C 260M
 -SUPERPLASTICIZER: ASTM C 494, TYPE F OR TYPE G
 -RETARDING: ASTM C 494/C 494M, TYPE B
- 5. MINIMUM CONCRETE COVER FOR REINFORCING STEEL SHALL BE NO LESS THAN 3".
- A 3/4" CHAMFER SHALL BE PROVIDED AT ALL EXPOSED EDGES OF CONCRETE IN ACCORDANCE WITH ACI 301 SECTION 4.2.4. UNLESS NOTED OTHERWISE.
- INSTALLATION OF CONCRETE EXPANSION/WEIGE ANCHOR SHALL BE DEE 7. INSTALLATION COUNTER E SHARMSDIMWEDGE ARWHOW SHALL BE PER MANUFACTURER'S WRITTER RECOMMENDED PROCEDURE. THE ANCHOR BOLT, DOWEL, OR ROD SHALL CONFORM TO MANUFACTURER'S RECOMMENDATION FOR EMBEDMENT DEPTH OR AS SHOWN ON THE DRAWINGS. NO REBAR SHALL BE CUT WITHOUT PRIOR APPROVAL FROM AN ATC ENGINEER WHEN DRILLING HOLES IN CONCRETE.
- 9. DO NOT WELD OR TACK WELD REINFORCING STEEL
- ALL DOWELS, ANCHOR BOLTS, EMBEDDED STEEL, ELECTRICAL CONDUITS, PIPE SLEEVES, GROUNDS AND ALL OTHER EMBEDDED ITEMS AND FORMED DETAILS SHALL BE IN PLACE BEFORE START OF CONCRETE PLACEMENT.
- 11. REINFORCEMENT SHALL BE COLD BENT WHENEVER BENDING IS REQUIRED.
- 12 DO NOT PLACE CONCRETE IN WATER ICE OR ON FROZEN GROUND
- 13. FOR COLD-WEATHER (ACI 306) AND HOT-WEATHER (ACI 301M) CONCRETE PLACEMENT, CONFORM TO APPLICABLE ACI CODES AND RECOMMENDATIONS. IN EITHER CASE, MATERIA'S CONTAINING CHLORIDE CALCIUM, SALTS, ETC. SHALL NOT

- BE USED. PROTECT FRESH CONCRETE FROM WEATHER FOR 7 DAYS, MINIMUM
- 14. ALL CONCRETE SHALL HAVE A "SMOOTH FORM FINISH
- 15 SPLICING OF REINFORCEMENT IS REPMITTED ONLY AT LOCATIONS SHOWN IN THE SPILLING OF REINFORCEMENT IS PERMIT IED UNLY AT LOCATIONS SHOWN IN INC CONTRACT DRAWINGS OR AS ACCEPTED BY THE REGINEER. UNLESS OTHERWISE SHOWN OR NOTED REINFORCING STEEL SHALL BE SPILCED TO DEVELOP ITS FULL TENSILE CAPACITY (CLASS A) IN ACCORDANCE WITH ACI 318.
- 16. DETAILING OF REINFORCING STEEL SHALL CONFORM TO "ACI MANUAL OF STANDARD PRACTICE FOR DETAILING REINFORCED CONCRETE STRUCTURES" (ACI
- 17. ALL SLAB CONSTRUCTION SHALL BE CAST MONOLITHICALLY WITHOUT HORIZONTAL CONSTRUCTION JOINTS, UNI FSS SHOWN IN THE CONTRACT INDAMINICS
- 18. LOCATION OF ALL CONSTRUCTION JOINTS ARE SUBJECT TO THE REQUIREMENTS OF THE CONTRACT DOCUMENTS, CONFORMANCE WITH ACL 116, AND ACCEPTANCE OF THE ENGINEER. DRAWINGS SHOWING LOCATION OF DETAILS OF THE PROPOSED CONSTRUCTION JOINTS SHALL BE SUBMITTED WITH REIMPORCING STEEL.
- SPLICES OF WWF, AT ALL SPLICED EDGES, SHALL BE SUCH THAT THE OVERLAP MEASURED BETWEEN OUTERMOST CROSS WIRES OF EACH FABRIC SHEET IS NOT LESS THAN THE SPACING OF THE CROSS WIRE PLUS 2 INCHES, NOR LESS THAN 6"
- 20. BAR SUPPORTS SHALL BE ALL-GALVANIZED METAL WITH PLASTIC TIPS
- ALL REINFORCEMENT SHALL BE SECURELY TIED IN PLACE TO PREVENT DISPLACEMENT BY CONSTRUCTION TRAFFIC OR CONCRETE. THE WIRE SHALL BE OF SUFFICIENT STRENGTH FOR INTENDED PURPOSE, BUT NOT LESS THAN NO. 18
- SLAB ON GROUND: COMPACT STRUCTURAL FILL TO 95% DENSITY AND THEN PLACE 6" GRAVEL BENEATH SLAB.

ELECTRICAL NOTES:

- ELECTRICAL DESIGN SHALL BE PERFORMED BY ELECTRICAL CONTRACTOR. STRUCTURAL DESIGN SHALL BE PERFORMED BY GENERAL CONTRACTOR. ELECTRICAL CONTRACTOR. SHALL ENSURE THAT ALL WORK COMPLIES WITH ALL APPLICABLE LOCAL AND STATE CODES AND NATIONAL ELECTRICAL CODE.
- ALL SUGGESTED ELECTRICAL ELEMENTS (SUCH AS BREAKER SIZES, WIRE SIZES, CONDUITS SIZES ARE FOR ZONING PURPOSES ONLY. IT IS THE RESPONSIBILITY TO OF THE ELECTRICAL CONTRACTOR TO CONFIRM COMPLIANCE WITH LOCAL ELECTRICAL CODES AND PASS ALL APPLICABLE AND NECESSARY INSPECTIONS. IN SOME EVENTS, IT MAY BE NECESSARY TO PERFORM AN ELECTRICAL LOAD STUDY TO VERIFY THE CAPACITY OF THE EXISTING SERVICE. THIS IS NOT THE RESPONSIBILITY OF CONCORDIA. IT IS THE RESPONSIBILITY OF CONCORDIA. IT IS THE RESPONSIBILITY OF
- CONTRACTOR SHALL FIELD LOCATE ALL BELOW GRADE GROUND LINES AND UTILITY LINES PRIOR TO CONSTRUCTION. CONTRACTOR IS RESPONSIBLE FOR RELOCATION OF ALL UTILITIES AND GROUND LINES THAT MAY BECOME DISTURBED OR CONFLICTING IN THE COURSE OF CONSTRUCTION.

ALL DISCREPANCIES FROM WHAT IS SHOWN ON THESE CONSTRUCTION DRAWINGS SHALL BE COMMUNICATED TO ATE ENGINEERING IMMEDIATELY FOR CORRECTION OR RE-DESIGN. FALURE TO COMMUNICATE DIRECTLY WITH ATE CHRISTERING OR ANY CHANGES FROM THE DESIGN CONDUCTED WITHOUT PRIOR APPROVAL FROM ATE ENGINEERING SHALL BE THE SOLE RESPONSIBILITY OF THE GENERAL CONTRACTOR.

161 INVERNESS DR W, 2ND FLOOR ENGLEWOOD, CO 80112





AT&T SITE ID: COL03271 AT&T FA CODE: 15312472 AT&T PACE #: MRUTH042446 ATC #: 420055 FAT_TIRE CO

1052 W VINE DR FORT COLLINS, CO 80521 (LARIMER COUNTY)

EXISTING 70'-0" MONOPINE TOWER NSB - LTE - 1C/2C/3C/4C/ 5G NR 1SR/5C

	ISSUED FOR:						
REV	DATE	DRWN	DESCRIPTION	QA			
Α	12-01-20	RRG	PRELIMINARY	EGG			



IT IS A VIOLATION OF LAW FOR ANY PERSON, UNLESS THEY ARE ACTING UNDER THE DIRECTION OF A LICENSED PROFESSIONAL ENGINEER,

GENERAL NOTES


SHEET NUMBER:

REVISION:

TEP#:

NOTE:

SITE SURVEY SHOWN BELOW WAS PROVIDED BY AMERICAN TOWER CORPORATION AND IS FOR REFERENCE ONLY

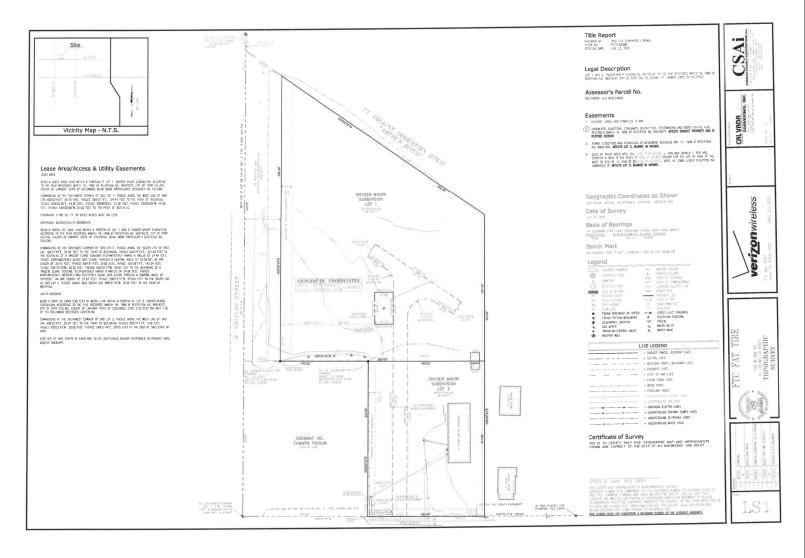





AMERICAN TOWER 19100 VON KARMAN AVE SUITE 200 IRVINE, CA 92612



TOWER ENGINEERING PROFESSIONALS 4710 E ELWOOD ST, STE 9 PHOENIX, AZ 85040 OFFICE: (480) 285-0036

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SHEET TITLE:

SITE SURVEY

SHEET NUMBER: **S-1**

REVISION:


Α TEP#:

200289 2440

SITE SURVEY

NOTES:

- THIS SITE PLAN REPRESENTS THE BEST PRESENT KNOWLEDGE AVAILABLE TO THE ENGINEER AT THE TIME OF THIS DESIGN. THE CONTRACTOR SHALL WIST THE SITE PRIOR TO CONSTRUCTION AND VERIFY ALL EXISTING CONDITIONS RELATED TO THE SCOPE OF WORK FOR THIS PROJECT.
- THE BROG. CABLE LADDER, CLAX. PRET. AND. CLAX. CABLE LAIR, SHOPN FOR RETERRICE CHAY. CONTRACTOR SHALL CONTRIBUTE AND ARRESTED CHAY. CONTRIBUTE CHAY. CHAY LOCATION OF ALL PROPOSED AND ESTIMAC COMMENT AND STRUCTURES ESPECTED WHO HAS FLAX. BEFORE UTILIZANG EXISTING CABLE SUPPORTS, COAX PORTS, INSTALLIANG NEW PORTS OF ANY OTHER COUPMENT, CONTRACTOR SHALL VERIFY ALL ASPECTS OF THE COMPONENTS MEET THE ACT SECRETICATIONS.
- THE THE RESPONSEINT OF THE CONTRACTOR TO CODEMANTE WITH THE STAFT REPRESENTANCE AND LOCAL UTBLY
 COMPANY FOR THE INSTALLATION OF CONDUING CONDICIONS, RESPONSE OF SOME OF ANY OTHER COMPANY
 REQUIRED FOR ELECTRICAL SERVICE. ALL ELECTRICAL WORK SHALL BE PERFORMED IN ACCORDANCE WITH LATEST
 EDITION OF THE STAFT AND NATIONAL COOSE, ORDANICES AND REQUIRENCE SPAPEL TO THIS PROJECT.
- PENDING UTILITY COORDINATION.

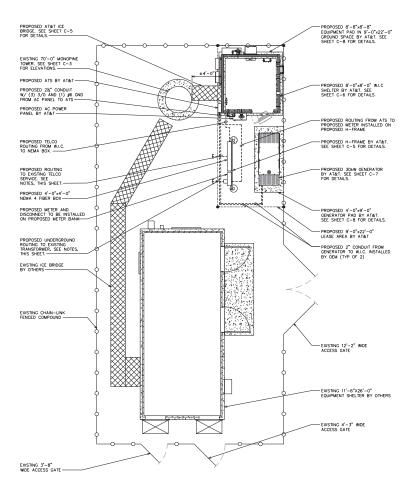





AMERICAN TOWER 19100 VON KARMAN AVE SUITE 200 IRVINE, CA 92612



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1052 W VINE DR FORT COLLINS, CO 80521 (LARIMER COUNTY)

EXISTING 70'-0" MONOPINE TOWER NSB - LTE - 1C/2C/3C/4C/ 5G NR 1SR/5C

	ISSUED FOR:						
REV DATE DRWN DESCRIPTION QA							
Α	12-01-20	RRG	PRELIMINARY	EGG			





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COMPOUND DETAIL

SHEET NUMBER: **C-1**


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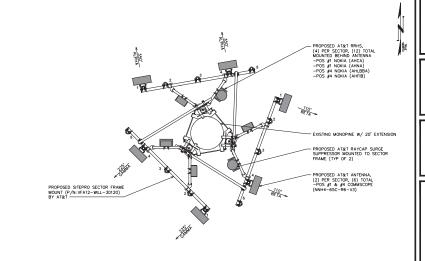
SCALE: ¼" = 1'-0" (24×36)

SCALE: 1 = 1-0" (11x17)

COMPOUND DETAIL



SCALE: N.T.S.

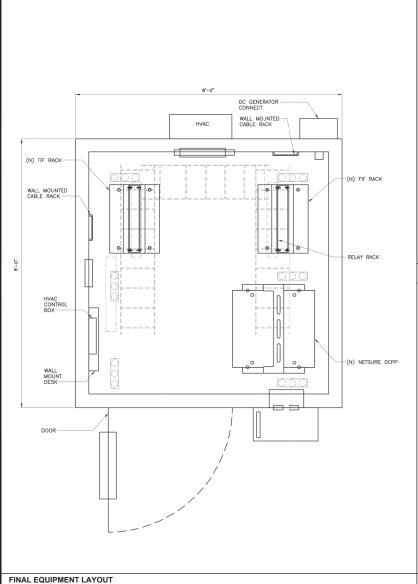

FINAL ANTENNA LAYOUT

SCALE: 1'-0" (24×36) SCALE: 36" = 1"-0" (11x17)

NOTE:

SCHEDULE EQUIPMENT SHOULD BE REFERENCED OFF RFDS LISTED ON SHEET T-1.

PROPOSED EQUIPMENT IN BOLD

		I	FINAL AN	TENNA	FEEDLINE S	CHEDU	JLE
SECTOR	POS.	MANUFACTURER (MODEL #)	MOUNTING HEIGHT	AZIMUTH (TN)	CABLE SIZE	CABLE LENGTH	SQUID/RRH/TMA/DIPLEXER [MODEL#]
ALPHA	1	COMMSCOPE (NNH4-65C-R6-V3)	€ @ 91"-0"±	350*			
ALPHA	2	-	-	-			(1) RAYCAP SOUID [DC9-48-60-24-8C-EV] (1) NOKIA RRH [AIRSCALE RRH 4T4R B5 160W AHCA]
ALPHA	3	-	-	-			(1) NOKIA RRH [AIRSCALE RRH 4T4R B30 100W AHNA (1) NOKIA RRH [AIRSCALE TRI RRH 4T4R B12/14/29 370W AHLBBA]
ALPHA	4	COMMSCOPE (NNH4-65C-R6-V3)	€ @ 91°-0°±	350°			(1) NOKIA RRH [AIRSCALE DUAL RRH 4T4R B25/66 320W AHFIB]
ALPHA	5	-	-	-			
BETA	1	COMMSCOPE (NNH4-65C-R6-V3)	€ @ 91"-0"±	110*	(2) FIBER TRUNKS	130'±	
BETA	2	-	-	-			(1) RAYCAP SQUID [DC9-48-60-24-8C-EV] (1) NOKIA RRH [AIRSCALE RRH 4T4R B5 160W AHCA]
BETA	3	=	-	-	(4) 2" CONDUITS		(1) NOKIA RRH [AIRSCALE RRH 4T4R B30 100W AHN. (1) NOKIA RRH [AIRSCALE TRI RRH 4T4R B12/14/29
BETA	4	COMMSCOPE (NNH4-65C-R6-V3)	€ @ 91°-0°±	110*			370W AHLBBA] (1) NOKIA RRH [AIRSCALE DUAL RRH 4T4R B25/66 320W AHFIB]
BETA	5	-	-	-			
DELTA	1	COMMSCOPE (NNH4-65C-R6-V3)	€ @ 91"-0"±	225*			
DELTA	2	-	-	-			(1) NOKIA RRH [AIRSCALE RRH 4T4R B5 160W AHCA]
GAMMA	3	-	-	-			(1) NOKIA RRH [AIRSCALE RRH 4T4R B30 100W AHN (1) NOKIA RRH [AIRSCALE TRI RRH 4T4R B12/14/2 370W AHLBBA]
GAMMA	4	COMMSCOPE (NNH4-65C-R6-V3)	€ @ 91'-0"±	225*			(1) NOKIA RRH [AIRSCALE DUAL RRH 4T4R B25/66 320W AHFIB]
GAMMA	5	-	-	-			





AMERICAN TOWER 19100 VON KARMAN AVE SUITE 200 IRVINE, CA 92612



AT&T SITE ID: COL03271 AT&T FA CODE: 15312472 AT&T PACE #: MRUTH042446 ATC #: 420055 FAT_TIRE CO

1052 W VINE DR FORT COLLINS, CO 80521 (LARIMER COUNTY)

EXISTING 70'-0" MONOPINE TOWER NSB - LTE - 1C/2C/3C/4C/ 5G NR 1SR/5C

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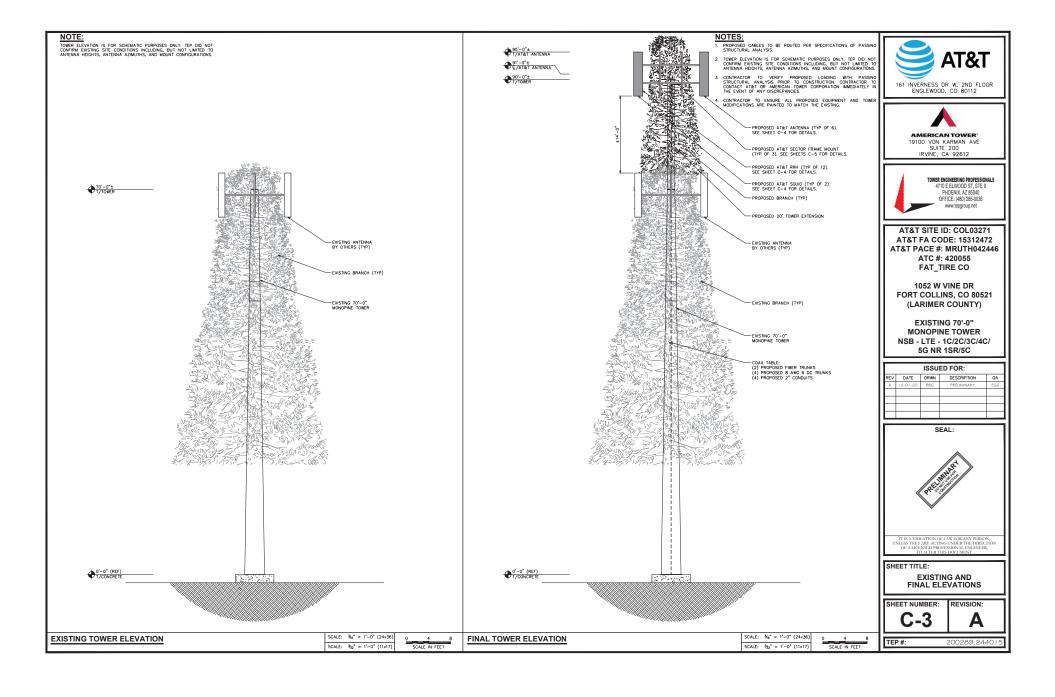
FINAL EQUIPMENT & ANTENNA LAYOUTS


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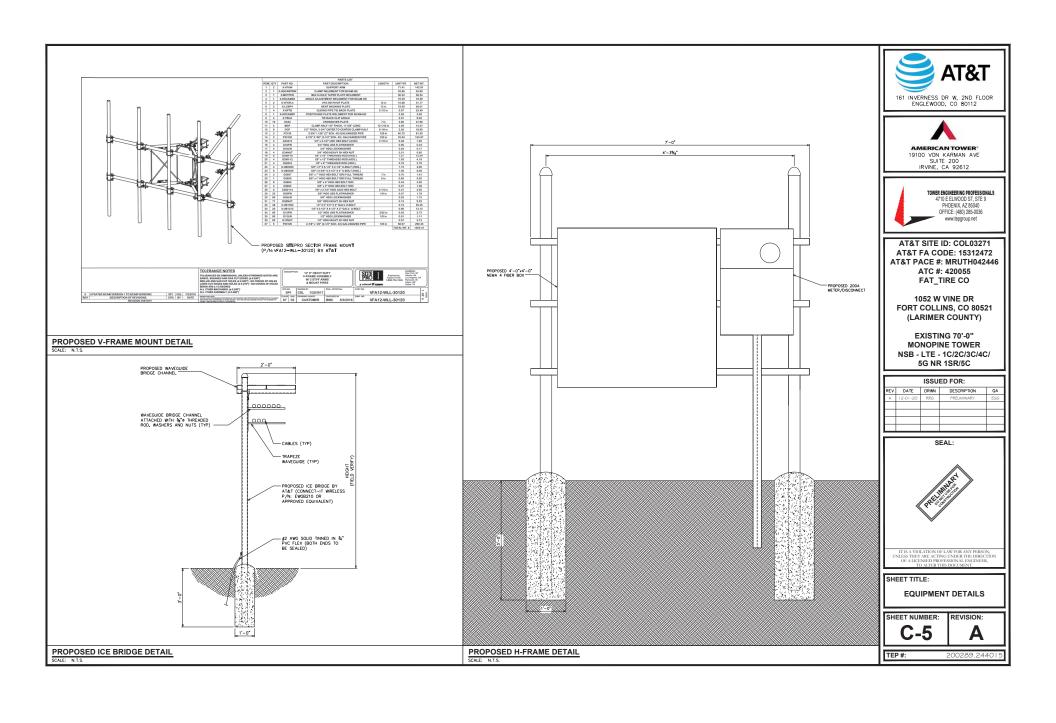
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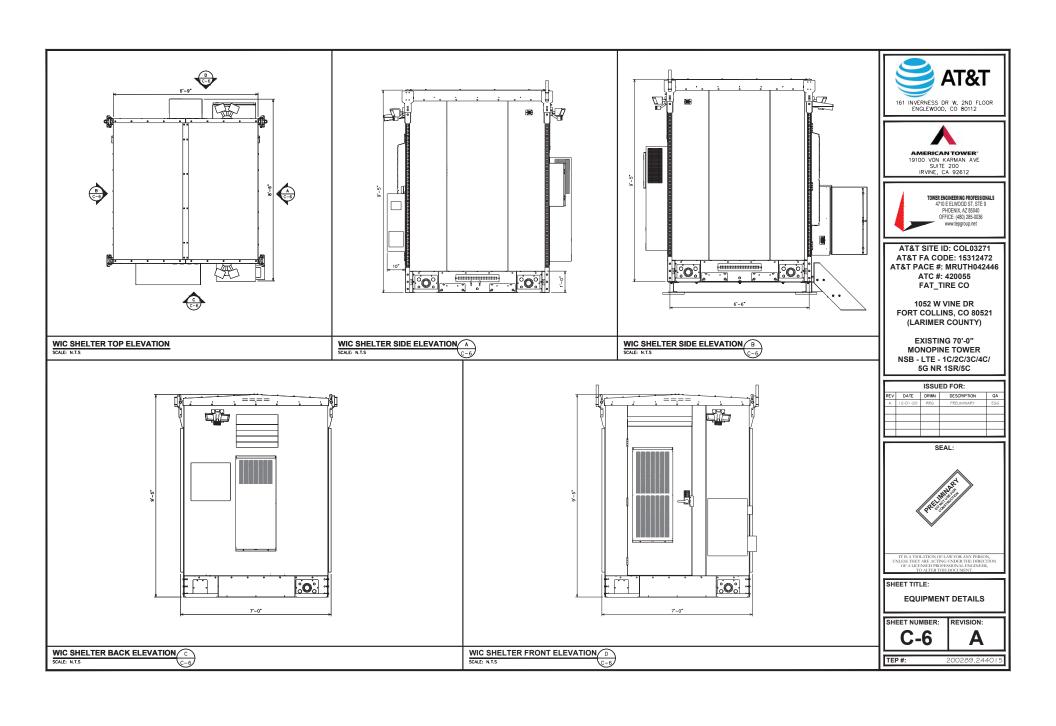
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FINAL ANTENNA SCHEDULE









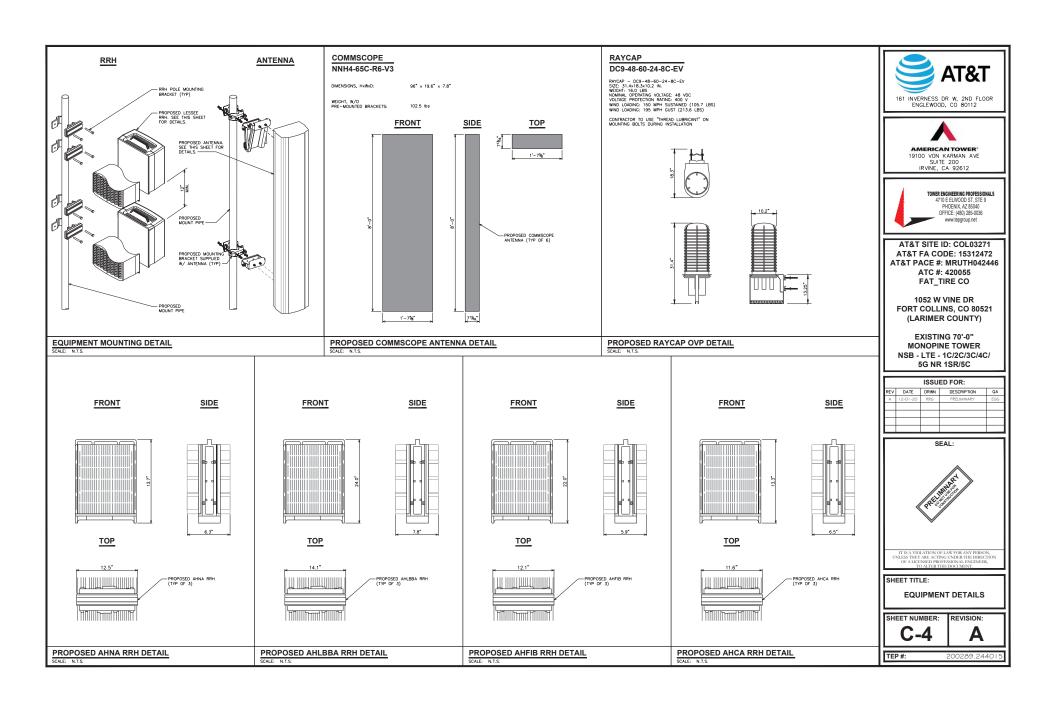


SD330 | 2.2L | 30 kW INDJSTRIAL DIESEL GENERATOR SET

Stantby Power Rating 30 kW, 38 kVA, 60 Hz Prim: Power Rating* 27 kV, 34 kVA, 60 Hz


GENERAC INDUSTRIAL



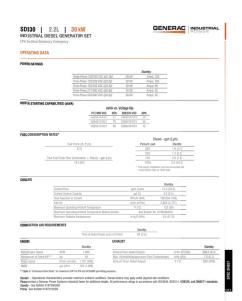





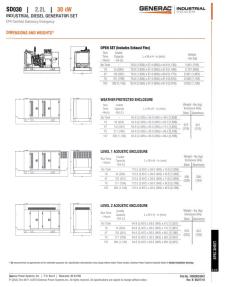





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GENERATOR DETAILS


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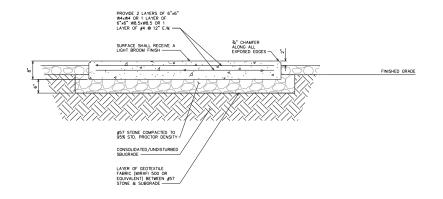
TEP#:

SD030 2.2L 30kW GENERATOR DETAILS

SCALE: N.T.S

SHEET NUMBER:



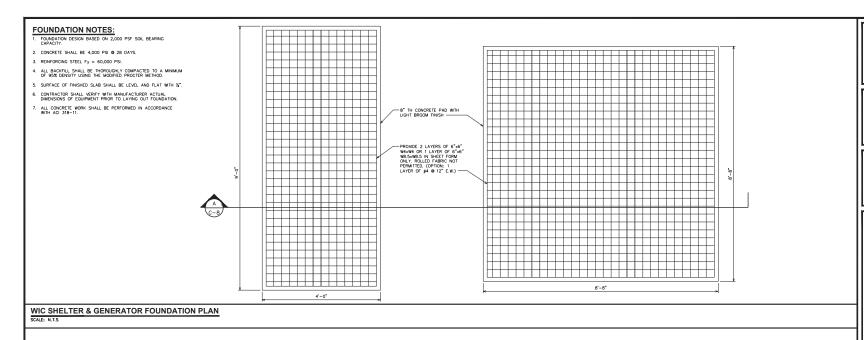

PAD SECTION A
SCALE: N.T.S
C-8

AT&T

161 INVERNESS DR W, 2ND FLOOR
ENGLEWOOD, CO 80112



AMERICAN TOWER*
19100 VON KARMAN AVE
SUITE 200
IRVINE, CA 92612



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HEET TITLE:


FOUNDATION DETAILS

SHEET NUMBER:

REVISION:

TEP #:


200289 2440

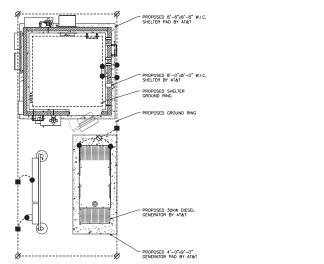

LEGEND EXOTHERMIC CONNECTION MECHANICAL CONNECTION = ANTENNA GROUND BAR MASTER GROUND BAR SCALE: 1'-0" (24×36) **EQUIPMENT GROUNDING PLAN** SCALE: 36" = 1"-0" (11x17)

PROPOSED PANEL SCHEDULE VALUES WERE CALCULATED BASED ON MAXIMUM PULL FROM EACH CONDECTED BREAKER. ACTUAL VALUES WILL VARY BASED ON SITE CONDITIONS.

		PRC	PO	SED			SCI	HED	ULE	·	
	120/240 VOLTS 1 PHASE	3 WIRE SURFACE MOUNTED								225A, 2 POLE MAIN BREAKER	
NO.	LOAD SERVED	ØA VA	ØB VA	AMP / POLE	L1	L2	AMP / POLE	ØA VA	ØB VA	LOAD SERVED	NO.
1	RECTIFIERS #1 & #2	2880	-	30/2	5760	-	30/2	2880	-	RECTIFIERS #3 & 4	2
3	RECTIFIERS #1 & #2	-	2880		-	5760		-	- 2880		4
5	RECTIFIERS #5 & 6	2880	-	30/2	2880	-	30/2	0	-	SPARE/OFF	6
7	KECHITIEKS #5 & 0	-	2880		-	2880		-	0		8
9	SPARE/OFF	0	-	30/2	0	-	30/2	0	-	SPARE/OFF	10
11	SFARE/OFF	-	0		-	0		-	0		12
13	SPARE/OFF	0	-	30/2	0	-	30/2	0	-	SPARE/OFF	14
15	SPARE/OFF	-	0		-	0		-	0		16
17	SPARE/OFF	0	-	30/2	0	-	30/2	0	-	SPARE/OFF	18
19	SFARE/OFF	-	0		-	0		-	0		20
21	SPARE/OFF	0	-	30/2	0	-	30/2	0	-	SPARE/OFF	22
23	SPARE/OFF	-	0		-	0		-	0		24
25	AC UNIT #1	1920	-	20/1	1920	-	-	-	-	BLANK	26
27	BLANK	-	-	-	-	0	-	-	-	BLANK	28
29	BLANK	-	-	-	0	-	-	-	-	BLANK	30
31	BLANK	-	-	-	-	0	-	-	-	BLANK	32
33	BLANK	-	-	-	0	-	-	-	-	BLANK	34
35	BLANK	-	-	-	-	0	-	-	-	BLANK	36
37	BLANK	-	-	-	0	-	-	-	-	BLANK	38
39	BLANK	-	-	-	-	0	-	-	-	BLANK	40
PHASE TOTALS (VA)						8640					
CURRENT PER PHASE (A)						72					
PEAK TOTAL (VA)						88	PEAK TOTAL (A)				
	125% DEMAND (13200	110	125% DEMAND (A)						

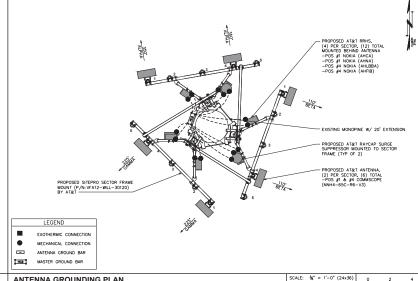

ANTENNA GROUNDING PLAN

SCALE: 1-0" (11x17)

161 INVERNESS DR W, 2ND FLOOR ENGLEWOOD, CO 80112



AMERICAN TOWER 19100 VON KARMAN AVE SUITE 200 IRVINE, CA 92612



AT&T SITE ID: COL03271 AT&T FA CODE: 15312472 AT&T PACE #: MRUTH042446 ATC #: 420055 FAT_TIRE CO

1052 W VINE DR FORT COLLINS, CO 80521 (LARIMER COUNTY)

EXISTING 70'-0" MONOPINE TOWER NSB - LTE - 1C/2C/3C/4C/ 5G NR 1SR/5C

IГ	ISSUED FOR:													
RE	v	DATE	DRWN	DESCRIPTION	QA									
1		12-01-20	RRG	PRELIMINARY	EGG									
ш														
ΙГ														
ΙП														
ιг														




SHEET TITLE: ELECTRICAL PANEL & GROUNDING PLANS


SHEET NUMBER: REVISION:


TEP#:


PROPOSED A/C PANEL

SCALE: N.T.S.

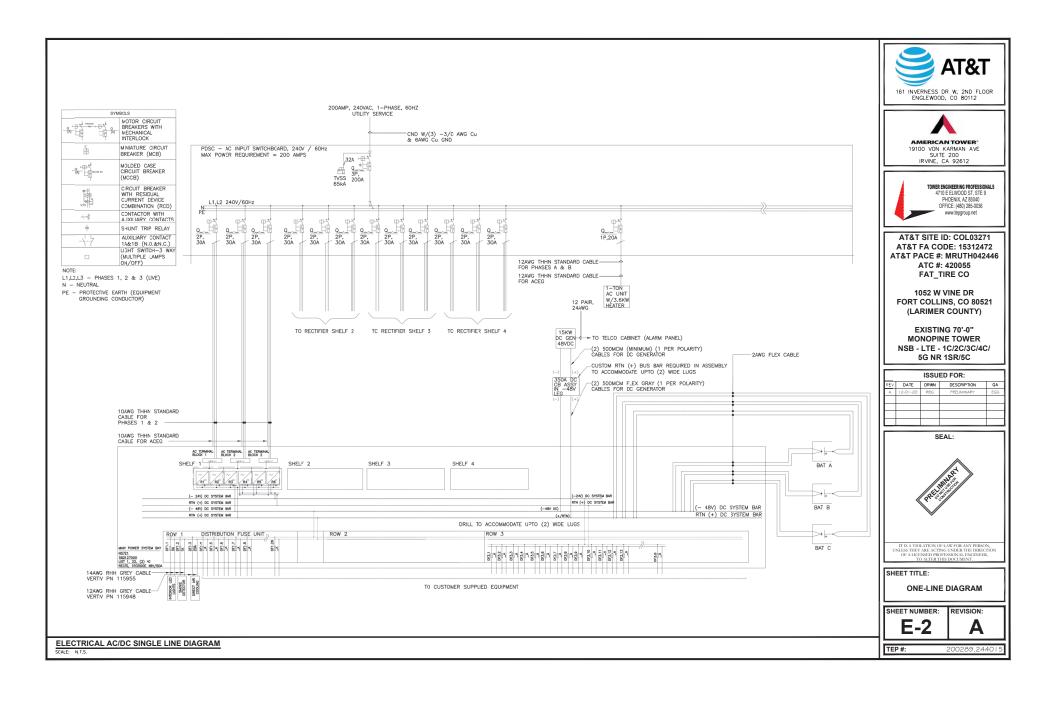


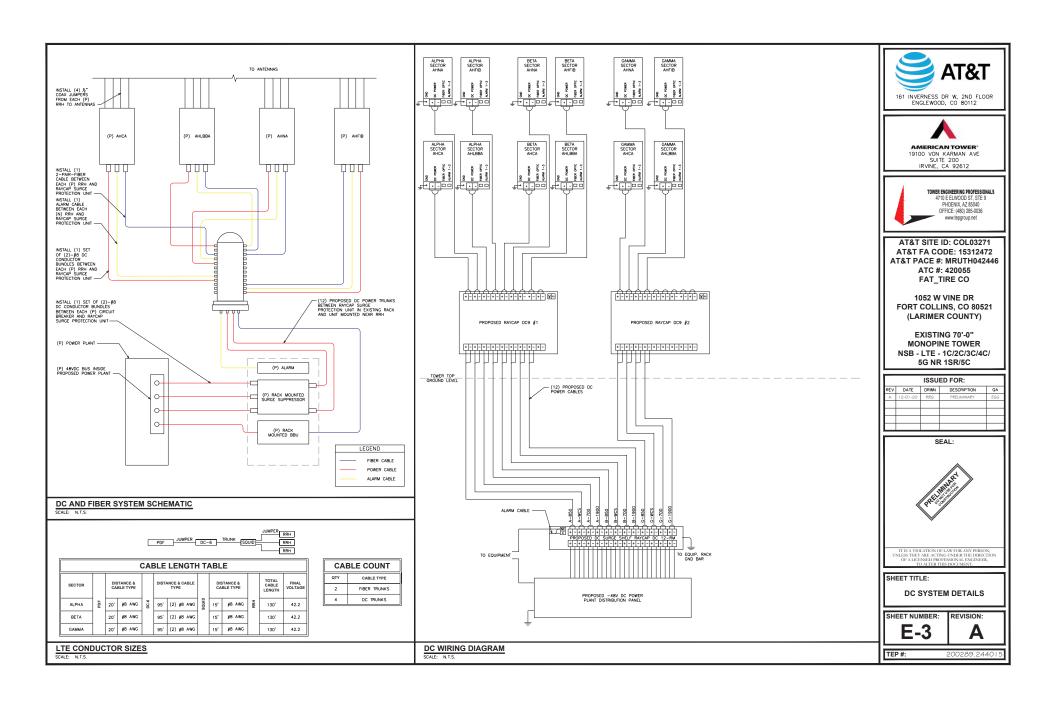

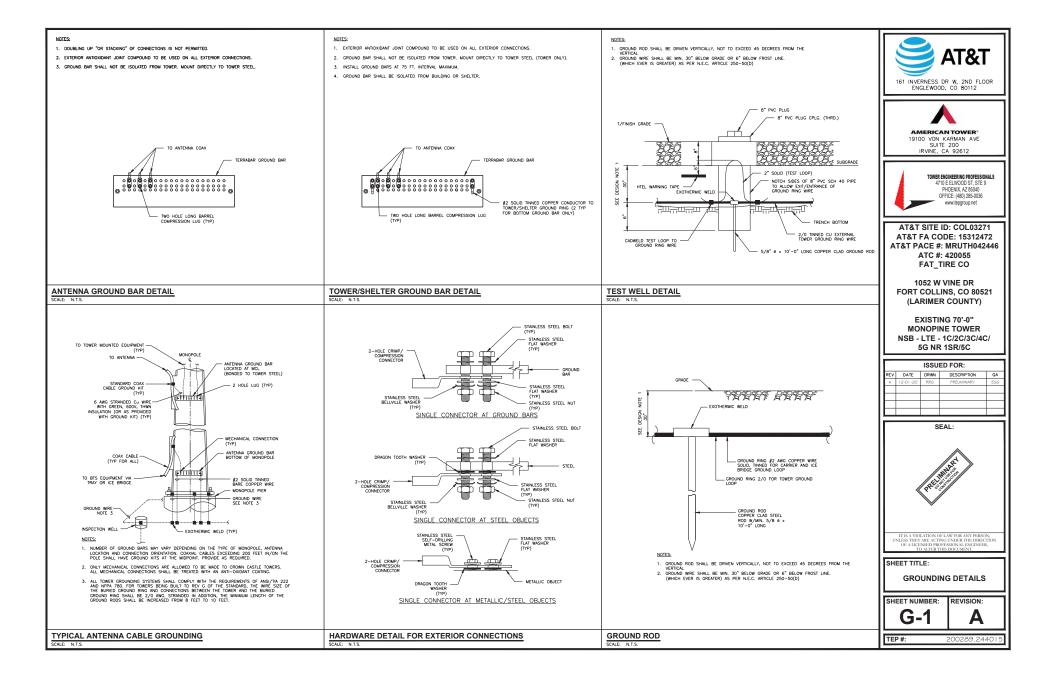

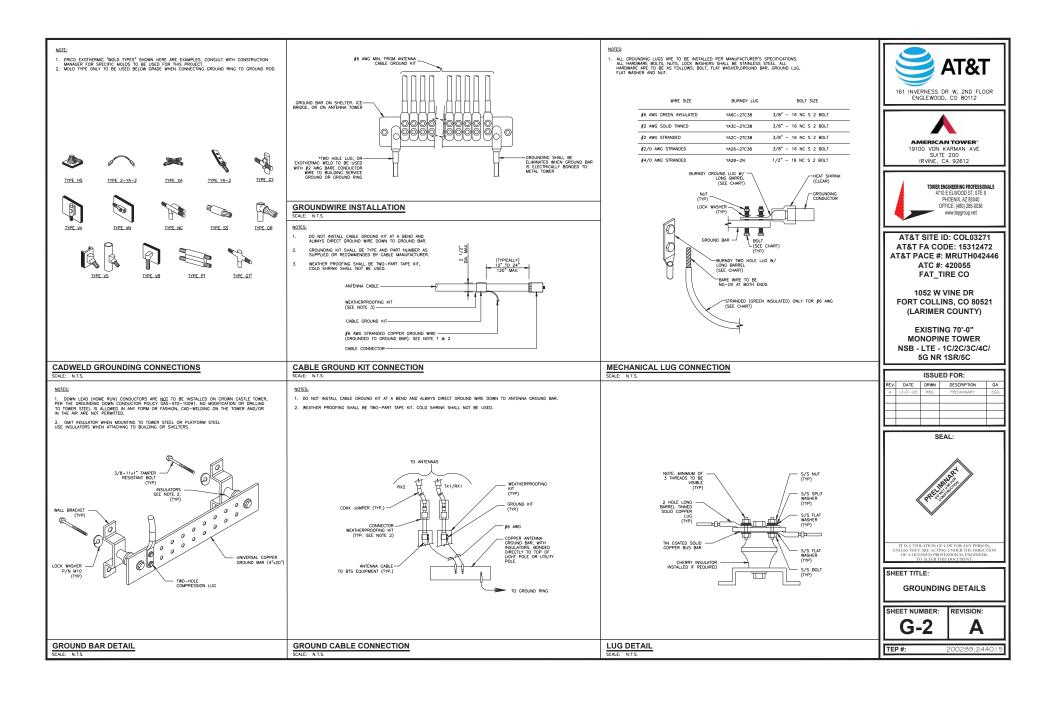


4000 Kechter Rd Single-Family Subdivision

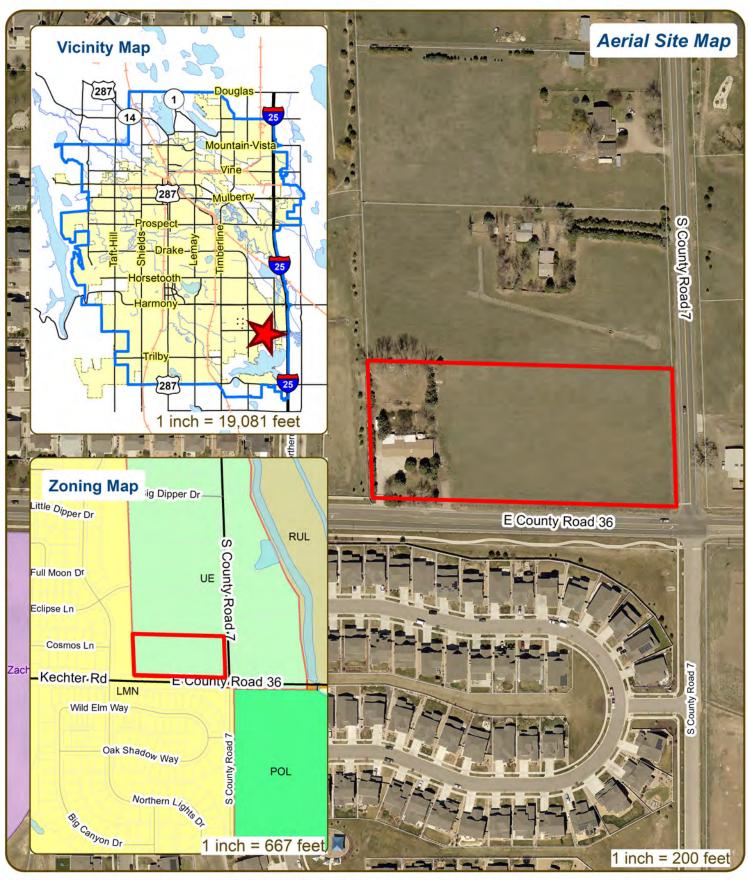

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CONCEPTUAL REVIEW: APPLICATION

General Information

change?

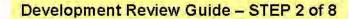All proposed development projects begin with Conceptual Review. Anyone with a development idea can schedule a Conceptual Review meeting to get feedback on prospective development ideas. At this stage, the development idea does not need to be finalized or professionally presented. However, a sketch plan and this application must be submitted to City Staff prior to the Conceptual Review meeting. The more information you are able to provide, the better feedback you are likely to get from the meeting. Please be aware that any information submitted may be considered a public record, available for review by anyone who requests it, including the media. The applicant acknowledges that they are acting with the owner's consent.

Conceptual Reviews are scheduled on three Thursday mornings per month on a "first come, first served" basis and are a free service. One 45 meeting is allocated per applicant and only three conceptual reviews are done each Thursday morning. A completed application must be submitted to reserve a Conceptual Review time slot. Complete applications and sketch plans must be submitted to City Staff on Thursday, no later than end of day, two weeks prior to the meeting date. Application materials must be e-mailed to currentplanning@fcgov.com. If you do not have access to e-mail, other accommodations can be made upon request.

At Conceptual Review, you will meet with Staff from a number of City departments, such as Community Development and Neighborhood Services (Zoning, Current Planning, and Development Review Engineering), Light and Power, Stormwater,

Water/Waste Water, Advance Planning (Long Range Planning and Transportation Planning) and Poudre Fire Authority. Comments are offered by staff to assist you in preparing the detailed components of the project application. There is no approval or denial of development proposals associated with Conceptual Review. At the meeting you will be presented with a letter from staff, summarizing comments on your proposal. *BOLDED ITEMS ARE REQUIRED* *The more info provided, the more detailed your comments from staff will be.* Contact Name(s) and Role(s) (Please identify whether Consultant or Owner, etc) ___ Mohsen Bagherian Business Name (if applicable) Peak Custom Villas of Colorado Your Mailing Address 2265 La Montana Way, Colorado Springs, CO Phone Number 719-321-0042 Email Address customvillaslic@aol.com Site Address or Description (parcel # if no address) 4000 Kechter Rd Description of Proposal (attach additional sheets if necessary) 11 1/2 acre residential lots Proposed Use 1/2 acre residential lots Existing Use house with 5 acre lot

Total Building Square Footage ______ S.F. Number of Stories N/A Lot Dimensions _____ Age of any Existing Structures Around 50 years Info available on Larimer County's Website: http://www.co.larimer.co.us/assessor/query/search.cfm If any structures are 50+ years old, good quality, color photos of all sides of the structure are required for conceptual. Is your property in a Flood Plain? □ Yes ■ No If yes, then at what risk is it? N/A Info available on FC Maps: http://gisweb.fcgov.com/redirect/default.aspx?layerTheme=Floodplains. Increase in Impervious Area Not sure at this time (Approximate amount of additional building, pavement, or etc. that will cover existing bare ground to be added to the site) Suggested items for the Sketch Plan: Property location and boundaries, surrounding land uses, proposed use(s), existing and proposed improvements

(buildings, landscaping, parking/drive areas, water treatment/detention, drainage), existing natural features (water bodies, wetlands, large trees, wildlife, canals, irrigation ditches), utility line locations (if known), photographs (helpful but not required). Things to consider when making a proposal: How does the site drain now? Will it change? If so, what will

