
### **Conceptual Review Agenda**

### Schedule for 08/20/20

Meetings hosted via Zoom Web Conferencing

Thurso	lay, August 20, 2020			
Time	Project Name	Applicant Info	Project Description	
9:15	428 N Grant Avenue Carriage House CDR200062	Dave Kaplan 970-682-8363 dave@elevateddesignbuild.com	This is a request to build a carriage house at 428 N. Grant Avenue (parcel # 9711219014). Access is taken from Grant Street to the west and a rear alley to the east. The site is approximately .3 miles east of N. Shields Street and approximately .3 miles north of Laporte Avenue. The property is within the Neighborhood Conservation Medium Density (NCM) zone district and is subject to Administrative (Type 1) Review.	Planner: Clark Mapes Engineer: Spencer Smith DRC: Brandy Bethurem Harras
10:15	5150 Snead Dr Replat and Rezone CDR200063	Mike McBride 970-402-0438 Mike@McBrideLA.com	This is a request to replat and rezone four parcels (parcel # 9601333901; 9601334902; 960133490; 9601300905) located at 5150 Snead Drive from Low Density Residential (RL) to General Commercial (CG). Access is taken from Snead Drive to the west. The properties are within the Low Density Residential (RL) and General Commercial (CG) zone districts and the process would be subject to City Council (Type 2) Review.	Planner: Clark Mapes Engineer: Morgan Stroud DRC: Tenae Beane
11:15	Spring Creek Multi-Family  CDR200064  NOTE: This property underwent a Preliminary Design Review on 3/11/2020 (PDR200002)	Russ Lee 970-224-5828 russ.lee@ripleydesigninc.com	This is a request to construct 348 dwelling units across 9 three-story and 1 four-story multi-family buildings directly north of Spring Creek Trail and south of Hobbit Street (parcel # 9723240001; 9723240002; 9723239001; 9723239002; 9723239003; 9723239004; 9723239005). The project is located directly east of S. Shields Street and approximately 700 feet south of W. Prospect Road. Future access will be taken from S. Shields Street to the west, and Hobbit Street to the north. The property is within the Neighborhood Commercial (NC) and Mixed-Use Medium Density (MMN) zone districts. The proposed project is subject to a Planning & Zoning Board (Type 2) Review.	Planner: Meagha Overton Engineer: Marc Virata DRC: Todd Sullivan

### 428 N Grant Ave Carriage House

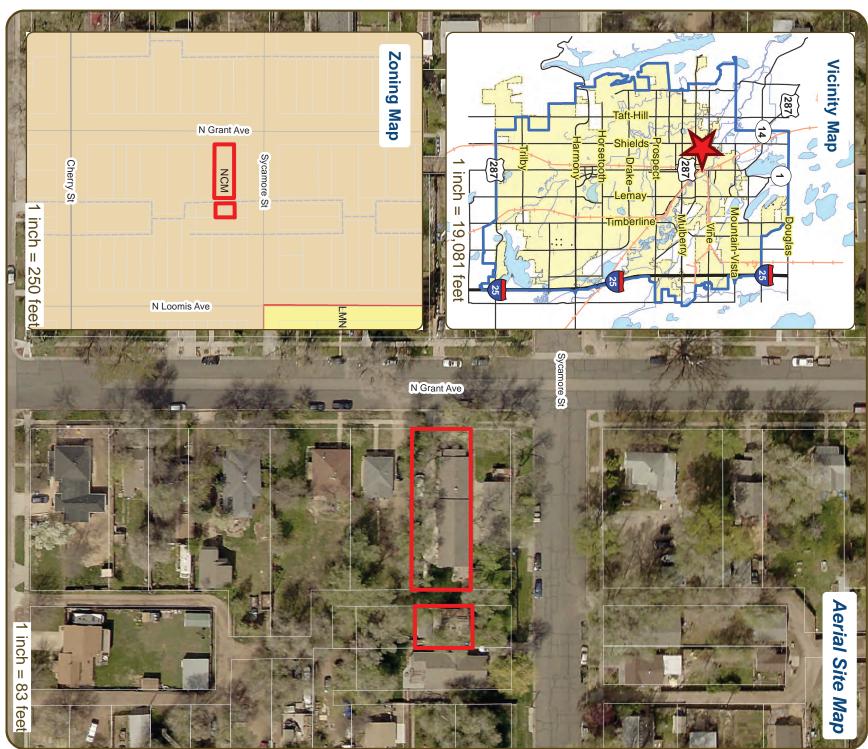







# Development Review Guide – STEP 2 of 8

### CONCEPTUAL *APPLICATION* REVIEW

## General Information

the owner's consent. <mark>available for review by anyone who requests it, including the media.</mark> The applicant acknowledges that they are acting with likely to get from the meeting. Please be aware that any information submitted may be considered a public record Staff prior to the Conceptual Review meeting. The more information you are able to provide, the better feedback you are not need to be finalized or professionally presented. However, a sketch plan and this application must be submitted to City All proposed development projects begin with Conceptual Review. Anyone with a development idea can schedule a Conceptual Review meeting to get feedback on prospective development ideas. At this stage, the development idea does

accommodations can be made upon request. Application materials must be e-mailed to currentplanning@fcgov.com. If you do not have access to e-mail, other <u>plans</u> must be submitted to City Staff on Thursday, no later than end of day, two weeks prior to the meeting date. A completed application must be submitted to reserve a Conceptual Review time slot. Complete applications and sketch free service. Conceptual Reviews are scheduled on three Thursday mornings per month on a "first come, first served" basis and are a One 45 meeting is allocated per applicant and only three conceptual reviews are done each Thursday morning

 $\circ$ Neighborhood Services (Zoning, Current Planning, and Development Review Engineering), Light and Poudre Fire Authority At Conceptual Review, you will meet with Staff from a number of City departments, such as Community Development and

	Age of any Existing Structures 40 years
S.F. Number of Stories 2 Lot Dimensions 52.5' x 140.69	Total Building Square Footage 594
Existing Use duplex	Proposed Use added ADU
Description of Proposal (attach additional sheets if necessary) New detached Studio	Description of Proposal (attach addition
f no address) 428 N Grant Ave	Site Address or Description (parcel # if no address) 428 N Grant Ave
Email Address dave@elevateddesignbuild.com	Phone Number 970-682-8363
r.	Your Mailing Address 144 Racquette Dr.
Design Build	Business Name (if applicable) Elevated Design Build
	David Kaplan, Designer
*BOLDED ITEMS ARE REQUIRED* *The more info provided, the more detailed your comments from staff will be.* Contact Name(s) and Role(s) (Please identify whether Consultant or Owner, etc)	*BOLDED ITEMS ARE REQUIRED* *T Contact Name(s) and Role(s) (Please ic
approval or denial of development proposals associated with Conceptual Review.  At the meeting you will be presented with a letter from staff, summarizing comments on your proposal	approval or denial of development proposals associated with
Comments are offered by staff to assist you in preparing the detailed components of the project application. There is no	Comments are offered by staff to assist you

If any structures are 50+ years old, good quality, color photos of all sides of the structure are required for conceptual. Info available on Larimer County's Website: http://www.co.larimer.co.us/assessor/query/search.cfm


Is your property in a Flood Plain? Pes No If yes, then at what risk is it?

Info available on FC Maps: http://gisweb.fcgov.com/redirect/default.aspx?layerTheme=Floodplains

(Approximate amount of additional building, pavement, or etc. that will cover existing bare ground to be added to the Increase in Impervious Area 594sf SF site)

# Suggested items for the Sketch Plan:

wetlands, (buildings, landscaping, parking/drive areas, water treatment/detention, drainage), existing natural features (water bodies Property location and boundaries, surrounding land uses, proposed use(s), existing and proposed improvements large trees, wildlife, canals, irrigation ditches), utility line locations (if known), photographs (helpful but not Things to consider when making a proposal: How does the site drain now? Will it change? If so, what will

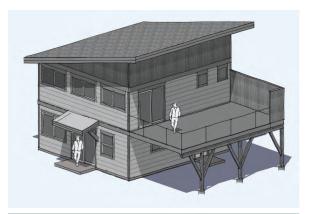



### PROJECT DESCRIPTION

DESIGN and CONSTRUCTION of a NEW SINGLE FAMILY RESIDENCE at: 428 N. Grant Avenue Fort Collins, CO 80521

### GENERAL NOTES:

A. THE LOCATION OF ALL DEVICES SUCH AS VALVES, METERS, CLEAN-OUTS, SWITCHES, EQUIPMENT, ETC. MUST BE APPROVED BY THE OWNER AND THE ARCHITECT IN THE FIELD PRIOR TO INSTALLATION. FAILURE TO OBTAIN APPROVAL FOR ALL SUCH DEVICES MAY RESULT IN RELOCATION OF THE

DEVICES AT NO COST THE OWNER.

### ENERGY CODE COMPLIANCE

CODE: CLIMATE ZONE: HEAT SOURCE: R-VALUE CEILINGS: R-VALUE EXTERIOR WALLS: 2018 IECC ZONE 5b FORCED AIR FURNACE R-49 MIN. R-21 MIN. R-30 MIN. R-VALUE FLOORS: R-VALUE BASEMENT WALLS: U-FACTOR DOORS: U-FACTOR WINDOWS: R-15 MIN. U-.32 MIN. U-.32 MIN.

### **DESIGN CRITERIA**

2018 IRC SINGLE FAMILY MAIN FLOOR CODE: OCCUPANCY: SQUARE FOOTAGE:

DECKS

378 sf

### LIST OF DRAWINGS

A-1 COVER SHEET
A-2 SITE PLAN
A-3 MAIN FLOOR PLAN
A-4 SECOND FLOOR PLAN
A-5 NORTH And SOUTH ELEVATIONS
A-6 EAST and WEST ELEVATIONS
A-7 SECTIONS C and D
A-9 SECTIONS E

E-1 ELECTRICAL/LIGHTING PLANS

ABBREVIATIONS

ABOVE FINISH FLOOR ARCHITECT BOTTOM OF \_ BLOCKING BEARING INSIDE DIMENSION INSIDE DIMENSIO INCH INSULATION INTERIOR MANUFACTURER MAXIMUM MECHANICAL MINIMUM NOT TO SCALE ON CENTER OUTSIDE DIMENSION CONC MASONRY UNIT CEILING
CASED OPENING
COLUMN
CONCRETE
CONTINUOUS
CONSTRUCTION OPPOSITE PLATE CONSTRUCTION
DRYER
DIMENSION
DOWN
DOOR
DOWNSPOUT
DETAIL
DISHWASHER
DRAWINGS PLATE
PLYWOOD
POINT
RADIUS
REFERENCE/REFER TO
REFRIGERATOR
REINFORCED/ING
REQUIRED REQUIRED ROOM ROUGH OPENING ROUGH SAWN SQUARE FEET SHOWER SIMILAR EXISTING EACH ELECTRICAL ELEVATION ELEVATION
EQUAL
EQUAL
EQUIPMENT
FACE OF CONCRETE
FACE OF MASONRY
FACE OF STUD
FIREPLACE
FINISH
FLOOR DRAIN STEFI STEEL STRUCTURAL SQUARE TO BE DETERMINED TIMBER FRAME THICK TOP OF FLOOR GAGE TYPICAL
UNLESS NOTED OTHERWISE
VERTICAL
WASHER GAGE
GALVANIZED
GENERAL CONTRACTOR
GYPSOM BOARD
GLU-LAM
HOSE BIB
HARDWARE
HORIZONTAL
HOUR WINDOW

### ARCHITECTURAL DESIGN

Elevated Design Build 144 Racquett Drive, Fort Collins, CO 80524

Phone: (970) 682-8363 Email: Dave@Elevateddesignbuild.com Contact: Dave Kaplan

GENERAL CONTRACTOR

Dave Fox 428 N. Grant Avenue Fort Collins, CO 80521

Phone: (970) 723-5446 Phone: Email: Contact

ELEVATED DESIGN BUILD 144 RACQUETTE DRIVE, FORT COLLINS, CO 80524

WITHOUT ANGLE DIAMETER CENTERLINE

> ENGINEER (T.B.D.) T.B.D.

Phone: Contact:

OWNER

ISSUE SET: BUDGET SET

SHEET TITLE: COVER

DRAWING DATE:

FOX STUDIO 428 NORTH GRANT AVENUE FORT COLLINS, CO 80521

07/20/2020


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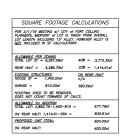
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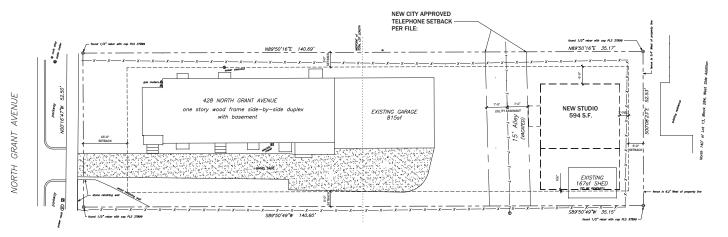
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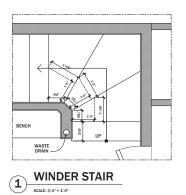
SITE PLAN


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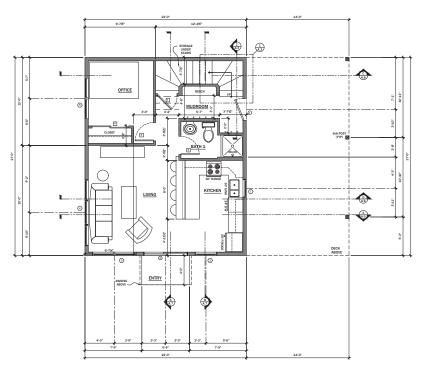
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A.2				







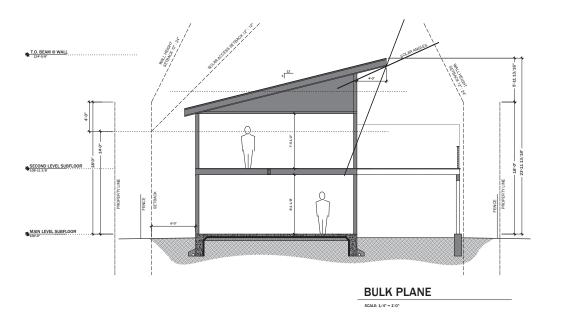

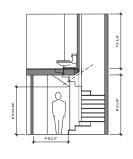

	WINDOW SCHEDULE (WINDOWS BY: ?? )							
SYM.	LOCATION	WIDTH	HEIGHT	STYLE	OPER	JAMB	NOTES	
0	KITCHEN	20,	30.	TRIPLE CSMT.	L-F-R	6-9/16"		
②	KITCHEN	3:-0"	4-0"	CSMT. DBL.	L-R	6-9/16"		
3	LIVING	6-0°	4-0"	CSMT. DBL.	L-R	6-9/16"		
0	LIVING	30.	30.	AWN, TRPL.	A-1-A	6-9/16"		
3	OFFICE	6-0	36.	CSMT. DBL.	L-R	6-9/16"		

	EXTERIOR DOOR SCHEDULE (DOORS BY: ?? )							
SYM.	LOCATION	WIDTH	HEIGHT	STYLE	OPERATION	JAMB	NOTES	
0	ENTRY	20,	6'-10"	ENTRY	LH	6-9/16"		
0	LIVING RM.	6-0.	67-107	SLIDER	1-A	6-9/16"		
3	STUDIO	60.	6-10"	SLIDER	I-A	6-9/16"	SEE PAGE A.4	

INTERIOR DOOR SCHEDULE (DOORS BY: ?? )							
SYM.	LOCATION	WIDTH	HEIGHT	STYLE	OPER.	JAMB	NOTES
1	STAIRS	2'-6"	6-8-	CUSTOM	RH	4-9/16"	VERIFY HEIGHT
2	PWDR RM.	2'-6"	6-8.	6 PANEL	RH	4-9/16"	
3	OFFICE	2'-6"	6-8.	6 PANEL	LH	6-9/16"	
4	OFFICE	6-0"	6-2.	6 PANEL DBL.	SLIDER	4-9/16"	

	INTERIOR FINISH SCHEDULE							
SYM.	MATERIAL	LOCATION	MANUF.	NOTES				
$\neg$								

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MAIN FLOOR PLAN V.3

SCALE: 1/4" = 1'-0" 594 S.F.




FOX STUDIO 428 NORTH GRANT AVENUE FORT COLLINS, CO 80521 SHEET TITLE:
MAIN FLOOR PLAN- V.3

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WINDOW SCHEDULE (WINDOWS BY: ?? )							
SYM.	LOCATION	WIDTH	HEIGHT	STYLE	OPER.	JAMB	NOTES
0	STUDIO SOUTH	2:-0"	2'-0"	CASEMENT	R	6-916"	
0	STUDIO EAST	6:-0"	31-01	CSMT. DBL.	L-R	6-916"	
0	STUDIO EAST	60.	3:-0"	CSMT. DBL.	L-R	6-916"	
0	STUDIO EAST	60.	31-0"	CSMT. DBL.	L-R	6-916"	
0	STUDIO NORTH	80.	3'-0"	TRIP. CSMT.	L-F-R	6-916"	
0	STUDIO NORTH	60.	3'-6"	CSMT. DBL.	L	6-916"	
0	STAIRWAY	2'-0"	2'-0"	CASEMENT	F	6-916"	

INTERIOR FINISH SCHEDULE							
SYM.	MATERIAL	LOCATION	MANUF.	NOTES			




SECOND FLOOR PLAN V.3
SCALE 1/4" - 1'0" 844 S.F.

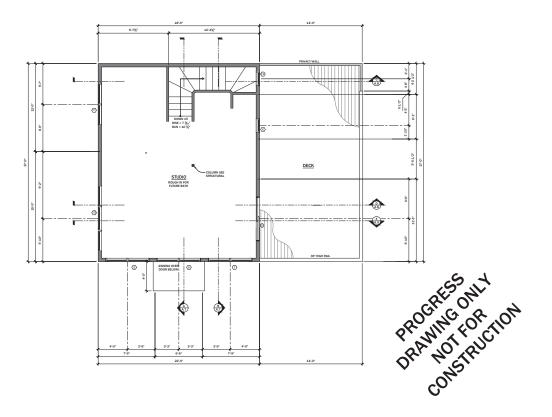


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	SECOND FLOOR PLAN- V.3	PROJECT: FOX STUDIO 428 NORTH GRANT AVENUE FORT COLLINS, CO 80521

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	EXTERIOR FINISH SCHEDULE						
SYM.	MATERIAL	MANUF.	NOTES				
1	HORIZ. SIDING						
2	VERTICAL SIDING						
3	COMPOSITE SHINGLES						
4	T & G SOFFIT						

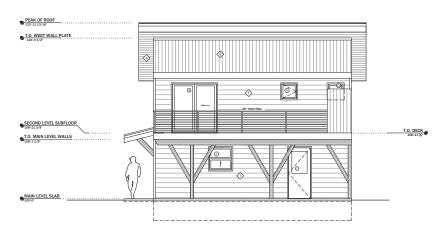

### SOUTH ELEVATION

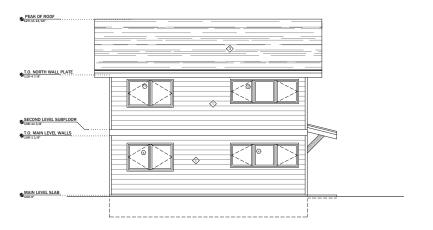SCALE: 1/4" = 1'-0"

PROGRESS ONLY

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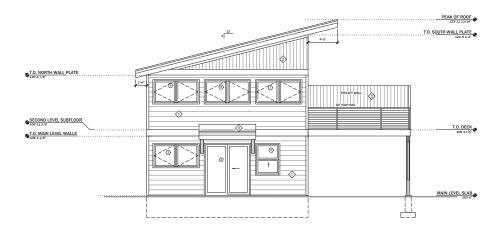
### NORTH ELEVATION

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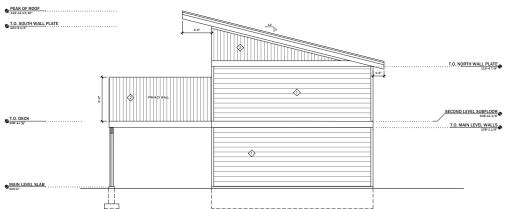


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	EXTE	RIOR FINISH SCH	EDULE
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2	VERTICAL SIDING		
3	COMPOSITE SHINGLES		
4>	T & G SOFFIT		



### **WEST ELEVATION**

SCALE: 1/4" = 1'-0"

PROGRESS MLT
PROGRESS ONLT
PRO

### **EAST ELEVATION**

SCALE: 1/4" = 1'-0"




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**A.6** 

6 of 10

SHEET NO:

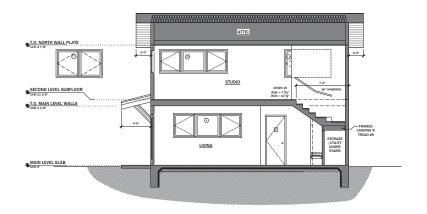

SECTION A

MAIN ROOF ASSEMBLY

SERVING ROOF

12 IL 12

BATH 1 FACING SOUTH

SCALE: 1/4" = 1.0"



SECTION A LIVING FACING NORTH
SECTION B LIVING FACING SOUTH
FROMET:
FOX STUDIO
428 NORTH GRANT AVENUE
FORT COLLINS, CO 80521

ISSUE SET:

BUDGET SET

DRAWING DATE:

07/20/2020

REVISIONS: DATE:


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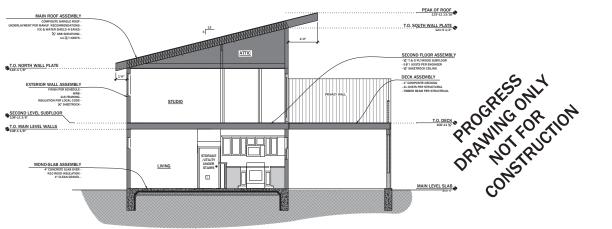
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FOx-Budget-V.3.1
07.20.2020

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SECTION C STAIR FACING EAST
SECTION D LIVING FACING EAST
SECTION D LIVING FACING EAST
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FOOLER STATEMENT FACING EAST
FOOLER STATEMENT FACING EAST
FOOLER STATEMENT FACING EAST
FORT COLLINS, CO 80521

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FILE NAME:
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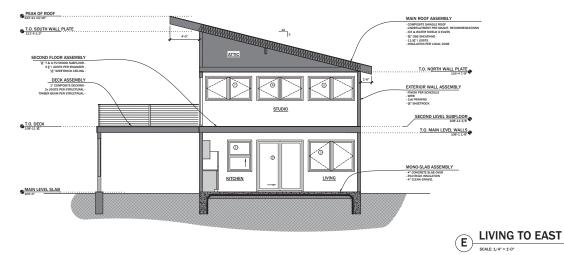
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**8.A** 

8 of 10

SHEET NO:

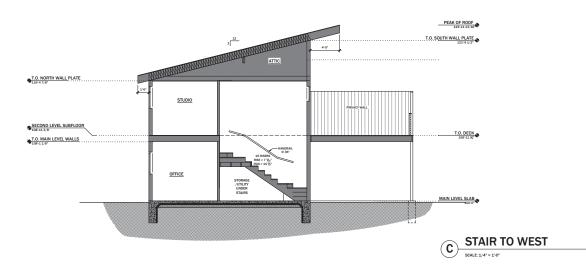




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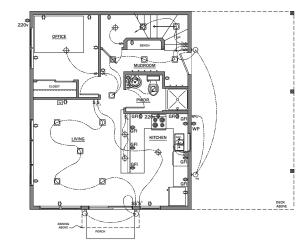
# PROCRESS ONLY DRAWNY FOR TION CONSTRUCTION

### LIGHTING/ELEC. LEGEND

7/////	2x FRAMED WALL
	METER
	PANEL
	CIRCUIT
<del>  0</del>	CEILING MOUNT
Ō	WALL MOUNT
	RECESSED
_∇ ⊕ ∇	TRACK
MS	MOTION SENSING
þ.v	LOW VOLTAGE LIGHT
	CEILING FAM
Ø	BATH FAN/LIGHT
0	BATH FAN
t4	FLUORESCENT
	UNDER CAB FIXTURE
\$	SWITCH
<b>\$</b> <sub>3</sub>	3-WAY SWITCH
\$.	4-WAY SWITCH
ø	I I Ov DUPLEX OUTLET
<b>Ø</b> GFI	GROUND-FAULT
<b></b>	WEATHER-PROOF
<b>Ф</b> 220v	220v DUPLEX OUTLET



SCALE: 1/4" = 1'-0"

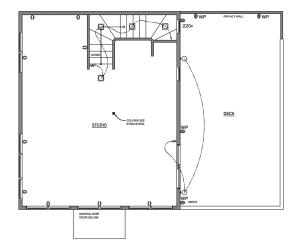

SHEET TITLE:
MAIN & SECOND FLOOR ELEC./LIGHTING PLAN FOX STUDIO 428 NORTH GRANT AVENUE FORT COLLINS, CO 80521

ISSUE SET: BUDGET SET DRAWING DATE: 07/20/2020 REVISIONS: DATE:

SCALE:

DRAWN BY: CHECKED BY: DK/JK FILE NAME: Fox-Budget-V.3.1 07.20.2020

1/4" = 1'-0" SHEET NO:

**E.1** 

10 of 10


ELEVATED DESIGN BUILD 144 RACQUETTE DRIVE, FORT COLLINS, CO 80524

SECOND FLOOR ELECTRICAL

SCALE: 1/4" = 1'-0"

MAIN FLOOR ELECTRICAL

## 5150 Snead Dr Replat and Rezone

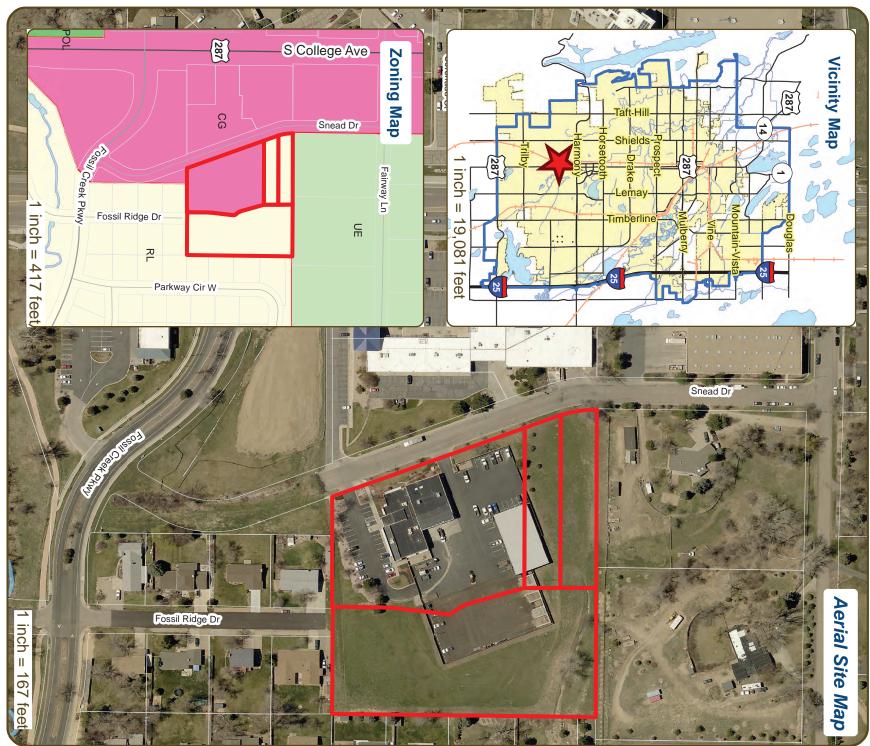







# **Development Review Guide - STEP 2 of 8**

### CONCEPTUAL *APPLICATION* REVIEW

## General Information

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Water/Waste Water, Advance Planning (Long Range Planning and Transportation Planning) and Poudre Fire Authority. Comments are offered by staff to assist you in preparing the detailed components of the project application. There is no approval or denial of development proposals associated with Conceptual Review. At the meeting you will be presented with Neighborhood Services (Zoning, Current Planning, and Development Review Engineering), Light and Power, Stormwater, At Conceptual Review, you will meet with Staff from a number of City departments, such as Community Development and

Business Name (if applicable) MMLA a letter from staff, summarizing comments on your proposal.

\*BOLDED ITEMS ARE REQUIRED\* \*The more info provided, the more detailed your comments from staff will be.\* Description of Proposal (attach additional sheets if necessary) Site Address or Description (parcel # if no address) 5150 Snead Dr, Fort Collins, Phone Number 970-402-0438 Your Mailing Address 2339 Spruce Creek Drive Mike McBride, Consultant Contact Name(s) and Role(s) (Please identify whether Consultant or Owner, etc) Replat to combine four lots into one and rezone to General Commercial Office 20 years Email Address Mike@McBrideLA.com S.F. Number of Stories **Existing Use** Office Lot Dimensions CO 80525

Age of any Existing Structures Total Building Square Footage Proposed Use


Is your property in a Flood Plain? □ Yes ■ No If any structures are 50+ years old, good quality, color photos of all sides of the structure are required for conceptual Info available on Larimer County's Website: http://www.co.larimer.co.us/assessor/query/search.cfm If yes, then at what risk is it?

Info available on FC Maps: http://gisweb.fcgov.com/redirect/default.aspx?layerTheme=Floodplains

(Approximate amount of additional building, pavement, or etc. that will cover existing bare ground to be added to the site) Increase in Impervious Area N/A SF

# Suggested items for the Sketch Plan:


wetlands, (buildings, landscaping, parking/drive areas, water treatment/detention, drainage), existing natural features (water bodies Property location and boundaries, surrounding land uses, proposed use(s), existing and proposed improvements large trees, wildlife, canals, irrigation ditches), utility line locations (if known), photographs (helpful but not Things to consider when making a proposal: How does the site drain now? Will it change? If so, what will

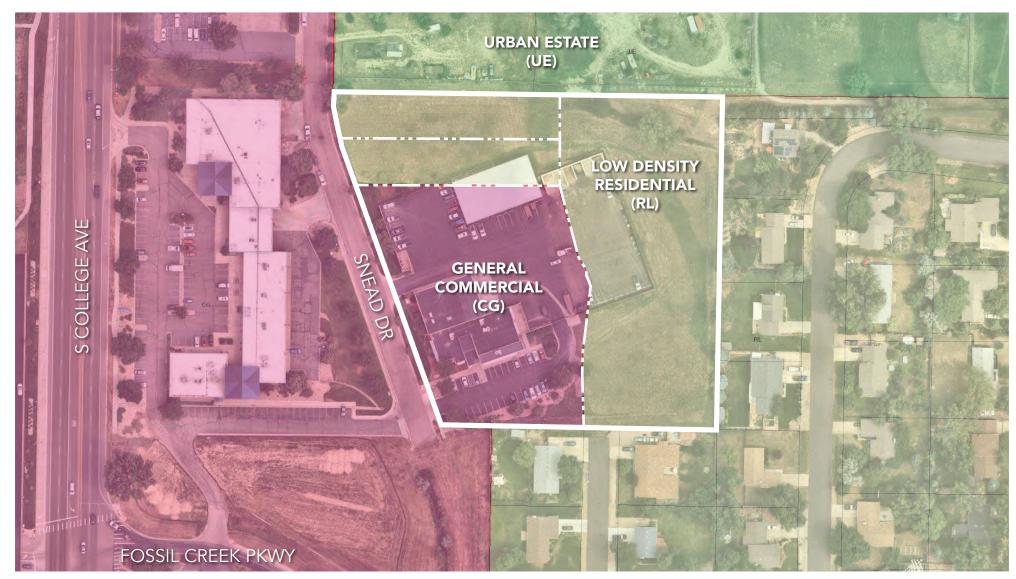

FORT COLLINS-LOVELAND WATER DISTRICT



# Spring Creek Multi-Family

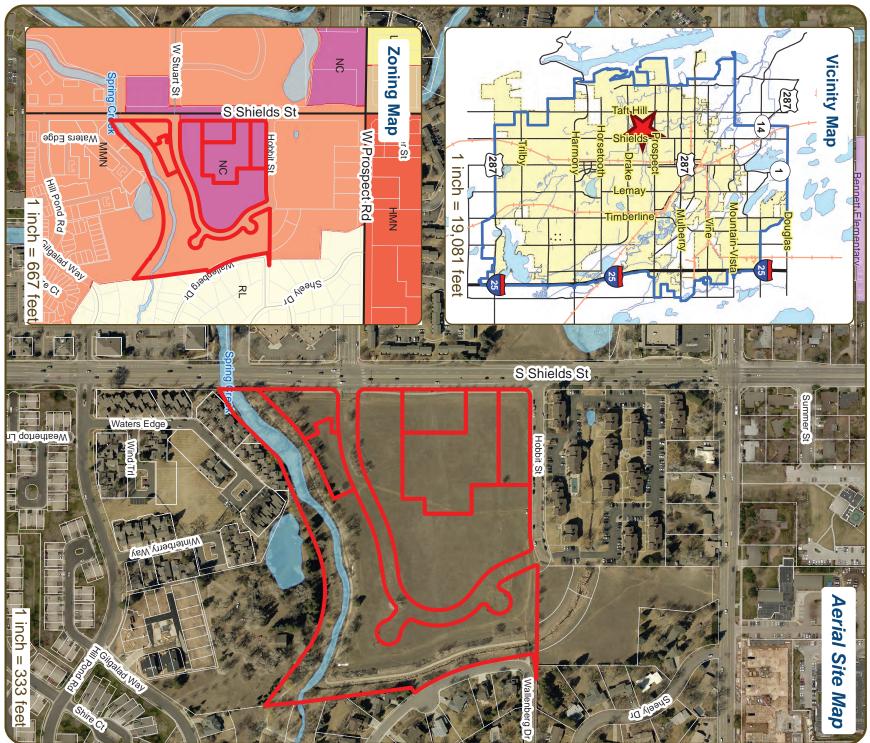







# **Development Review Guide - STEP 2 of 8**

### CONCEPTUAL APPLICATION REVIEW

## General Information

the owner's consent. likely to get from the meeting. Please be aware that any information submitted may be considered a public record Staff prior to the Conceptual Review meeting. The more information you are able to provide, the better feedback you are not need to be finalized or professionally presented. However, a sketch plan and this application must be submitted to City All proposed development projects begin with Conceptual Review. Anyone with a development idea can schedule a Conceptual Review meeting to get feedback on prospective development ideas. At this stage, the development idea does vailable for review by anyone who requests it, including the media. The applicant acknowledges that they are acting with

Conceptual Reviews are scheduled on three Thursday mornings per month on a "first come, first served" basis and are a accommodations can be made upon request. Application materials must be e-mailed to currentplanning@fcgov.com. If you do not have access to e-mail, other <u>plans</u> must be submitted to City Staff on Thursday, no later than end of day, two weeks prior to the meeting date. A completed application must be submitted to reserve a Conceptual Review time slot. Complete applications and sketch free service. One 45 meeting is allocated per applicant and only three conceptual reviews are done each Thursday morning

Water/Waste Water, Advance Planning (Long Range Planning and Transportation Planning) and Poudre Fire Authority. Comments are offered by staff to assist you in preparing the detailed components of the project application. There is no approval or denial of development proposals associated with Conceptual Review. At the meeting you will be presented with Neighborhood Services (Zoning, Current Planning, and Development Review Engineering), Light and Power, Stormwater, At Conceptual Review, you will meet with Staff from a number of City departments, such as Community Development and

a letter from staff, summarizing comments on your proposal.

\*BOLDED ITEMS ARE REQUIRED\* \*The more info provided, the more detailed your comments from staff will be.\*

Business Name (if applicable) Ripley Design Inc Watermark Residential - Jessica Tuttle (Applicant) Russ Lee/Linda Ripley, Ripley Design Inc. (Consultant) Contact Name(s) and Role(s) (Please identify whether Consultant or Owner, etc)

Site Address or Description (parcel # if no address) 9723240001; 9723239003; 9723239002 Phone Number (970) 224-5828 Your Mailing Address 419 Canyon, Suite 200, Fort Collins, CO 80521 Email Address russ.lee@ripleydesigninc.com

Age of any Existing Structures no existing structures Total Building Square Footage TBD Proposed Use Multi-Family/Mixed-Use S.F. Number of Stories **Existing Use** Undeveloped 3&4 Lot Dimensions 19.55 AC

**Description of Proposal** (attach additional sheets if necessary)

See attached narrative

If any structures are 50+ years old, good quality, color photos of all sides of the structure are required for conceptual. Info available on Larimer County's Website: http://www.co.larimer.co.us/assessor/query/search.cfm

Is your property in a Flood Plain? ■ Yes □ No If yes, then at what risk is it? 100 year floodplain along creek and ditch

Info available on FC Maps: http://gisweb.fcgov.com/redirect/default.aspx?layerTheme=Floodplains

(Approximate amount of additional building, pavement, or etc. that will cover existing bare ground to be added to the site) Increase in Impervious Area TBD - more than 1000 SF S.F

# Suggested items for the Sketch Plan:

wetlands, (buildings, landscaping, parking/drive areas, water treatment/detention, drainage), existing natural features (water bodies Property location and boundaries, surrounding land uses, proposed use(s), existing and proposed improvements large trees, wildlife, canals, irrigation ditches), utility line locations (if known), photographs (helpful but not Things to consider when making a proposal: How does the site drain now? Will it change? If so, what will

# Watermark at Spring Creek

## Project Narrative

(a) What are you proposing/use?

Stuart Street and Shields Street. approximately 3000 square feet of commercial space and is proposing to leave an out lot for approximately 6000 square feet of commercial space in a future phase located near the intersection of Watermark Residential is proposing to construct 348 Class A multi-family dwelling units, along with

(b) What improvements and uses currently exist on the site?

The site is currently undeveloped.

(c) Describe the site circulation (auto and pedestrian), parking and how it coordinates with the

existing neighborhood.

Spring Creek drainage prevents vehicular access to the south and to the east. Standard parking spaces Spring Creek Trail is adjacent to the site along the east and south. The Trail in combination with the private drive with diagonal parking is proposed to connect from Shields Street to Hobbit Street. are provided in the quantities required by the LUC with up to 40% compact spaces proposed Primary vehicular access is from Shields Street at the signalized intersection at Stuart Street. A street-like

street trees and a bus stop exist along Shields Street and detached walks and street trees are proposed complete and grading can be reviewed for a safe connection that is not too steep. A detached sidewalk along the street-like private drive. Two points of pedestrian and bike access to the Trail are proposed along the east side of the project. Watermark plans to review other possible trail connections with Northern engineering once survey is

(d) Describe site design and architecture.

buildings are placed along streets where possible with parking located behind, away from public view but convenient for residents. and neighborhood. Safety and convenience of residents is also a primary design objective. To that end This upscale multi-family project is designed to be visually attractive within the context of the community

Other factors that affected the site plan include:

- A forty-foot wide, existing sanitary sewer easement that crosses the site east to west located to the north.
- A twenty-foot wide, existing waterline easement that crosses the site east to west located to the

- Hobbit Street determined the logical connection point. The need for a street connection from Shields to Hobbit. The existing cul-de-sac right-of-way on
- stories, while Mixed-Use buildings in the NC zone can be five stories. Neighborhood Commercial. Multi-family buildings in the MMN zone cannot exceed three Mixed-Use Neighborhood, while approximately 6 acres to the southwest is zoned NC – Two zone districts exist on the site. The majority of the site is zoned MMN – Medium Density
- development setback is required from the eastern drainage. 100-foot development setback is required from Spring Creek on the south and a 50-foot The City requires Natural Habitat Buffer Zones along the east and south sides of the project. A

plans, walk out balconies or porches, in unit washer and dryer and high-end finishes. The required bike siding and stone are used as shown in the enclosed elevations. The units feature spacious, open floor style buildings have 3 points of pedestrian access at sidewalk entrances along the parking side of the is looking into space in the enclosed corridors and units to meet code requirements. parking will be designed to allow for 60% covered parking within the multifamily buildings. The architect Fort Collins developments including the neighborhood to the east. Timber accents, fiber cement lap materials and a neutral color scheme to tie into the natural landscape and are complimentary to existing buildings. Each access point enters an enclosed corridor. The exterior of the buildings consists of a mix of between one 4-story mixed use building and nine 3-story, garden style walk-up buildings. The garden The proposed project consists of a 348-unit, Class A multifamily residential rental community divided

the table below. The exact unit mix will be designed once PDR comments are received and addressed The unit mix will be approximately 40% one bedrooms, 50% two bedrooms and 10% three bedrooms per

965 SF	348 Units	Totals/Wtd. Averages	
1,360 SF	18 Units	Bath	C2
		Three Bedroom Two	
1,243 SF	18 Units	Bath	C1
		Three Bedroom Two	
1,173 SF	72 Units	Two Bedroom Two Bath	B2
1,045 SF	102 Units	Two Bedroom Two Bath	B1
754 SF	54 Units	One Bedroom One Bath	A2
682 SF	84 Units	One Bedroom One Bath	A1
Rentable Square Feet	No. of Units		Unit Type

trash and recycling enclosure is located near the Hobbit Street connection. Watermark's Property clubhouse in the 4-story building with recreational and leasing space, and dog park. Tenants will have ample surface parking provided within the property, with covered detached garage parking options. One The community will also have various amenity areas, including a pool, grill stations, an integrated refuge to the enclosure. Management Division will offer full valet trash service so that residents are not required to take their

capped at 365 and the "rent-by-the-bedroom" leasing model is not allowed family homes in the adjacent neighborhood. The maximum number of multi-family dwelling units is neighborhood. The Conditions require a buffer and transition between multi-family buildings and single-The zoning was approved along with Conditions designed to ensure compatibility with the adjacent In 2017 the site was re-zoned to reduce the amount of land zoned NC and increase the MMN portion

The proposed Watermark Residential project responds to these conditions in following ways:

- Watermark is proposing 348 multi-family dwelling units, substantially below the 365 cap
- The multi-family units are proposed to be upscale and not marketed to students
- No 3-story multi-family buildings directly face the neighborhood.
- 193 feet away and the applicant is committed to landscape screening on the east end of Building While the end of Building E is visible from the neighborhood, the nearest single-family home is
- building height, as well as to buffer the neighborhood from parking lot headlights and sounds. One-story garages are placed along the eastern edge of the project to create a transition of
- exceeds City requirements. The garages are substantially setback creating a natural area along the Spring Creek Trail that will provide high quality wildlife habitat and further buffer the neighborhood. Watermark will provide berming and enhancement plantings that

access Shields Street at a signalized intersection. Currently their access on to Shields Street is unsafe for left turn movements. benefit if Watermark is built because the proposed street connection to Hobbit will allow them to Watermark are multi-family projects with similar size buildings. Landmark Apartment residents will The student-oriented Landmark Apartments exists north of the project site. Both Landmark and

(f) Is water detention provided? If so, where?

conceptual site plan. Yes. Stormwater detention will be provided at the southeast corner of the site, as depicted on the

(g) How does the site drain now (on and off site)? Will it change? If so, what will change?

affected by, this development. Creek. General drainage patterns will be maintained. Off-site flows are not expected to influence, nor be The site currently drains from west to east/southeast into the Canal Importation Channel and into Spring

(h) What is being proposed to treat run-off?

anticipated A combination of LID techniques and extended detention with water quality capture volume are

(i) How does the proposal impact natural features?

NHBZ area that far exceeds the encroachment. the project. While development is proposed to encroach into the NHBZ, the project provides additional Natural Habitat Buffer Zones (NHBZ) and enhancements are provided along the east and south sides of

people were cutting through and creating dirt paths to Shield's Street. state. Clearly defined trail connections will be made and the development will block locations where Watermark intends to minimize the disruption inside the buffer space. The area is to remain in a natural

sprinklers? (j) Do any existing structures have automatic fire sprinklers? Will the new structures have fire

There are no existing structures. New structures will be sprinklered per code.

(k) Are there any unusual factors and/or characteristics are present that may restrict or affect your

in certain locations the previous rezoning plan supported by the neighbors to the east. Watermark has worked through multiple iterations of the site plan in order to closely match and improve

(I) Have you previously submitted an application?

forward over the years, the most recent one being Spring Creek Multi-Family PDR200002 in March 2020. Watermark has not submitted a previous application. Several development proposals have been brought

(m) What specific questions, if any, do you want addressed?

- 1. pedestrian connectivity standard? Will the City staff support a Modification for Building D on the west side, not meeting the
- 2 landscape architect more flexibility for a better community park space adjacent to Shields Street. within the NC District, however, the applicant believes the large open space area would allow the provide a "central feature or gathering place" in the NC District. The pocket park is only partially with plaza area on the south side of the 4-story building are intended to fulfill the requirement to neighborhood pocket park adjacent to the Neighborhood Commercial District. This park along Watermark proposes to use the space north of the 4-story mixed-use building for a building fulfills the requirement without the need for a Modification? Would City staff agree that the pocket park and plaza space on the south side of the 4-story
- ω. Are there any repayments for previous public street improvements?
- 4 portion of the development? If not, when would this occur? Has the City stormwater department completed the cleanout of Spring Creek along the southern
- 5 development on Stuart Street? Will the City implement and install the traffic signal arm for the westbound movement out of the
- 9 How will cost responsibilities be determined for signal changes at Stuart and Shields?
- .7 Is the Stormwater Utility amenable to a "beat the peak" analysis (similar to Landmark Apartments Expansion) and/or full-spectrum detention?











Scale: 3/32" = 1'-0"







SIDE ELEVATION - BUILDING TYPE A



FRONT ELEVATION - BUILDING TYPE B Scale: 3/32" = 1'-0"





Scale: 3/32" = 1'-0'



-Fiber Cement Lap Siding

SIDE ELEVATION - BUILDING TYPE B Scale: 3/32" = 1'-0"



FRONT ELEVATION - BUILDING TYPE C Scale: 3/32" = 1'-0"







SIDE ELEVATION - BUILDING TYPE C



Fiber Cement -Board & Batten Fiber Cement -Fiber Cement -Decorative -Lap Siding Lap Siding Bracket T/O Roof +48'-10" Asphalt Shingles — B/O Soffit +32'-0" - $\blacksquare$ # --- $\blacksquare$ Ш ш # ---- $\blacksquare$ --- $\blacksquare$ ------# H --ш Ш 1111 ---ш Щ Stone Veneer 1st Floor Stone Veneer BACK ELEVATION - BUILDING TYPE D

Scale: 3/32" = 1'-0"


2nd Floor +10'-8"

1st Floor





Stone Veneer

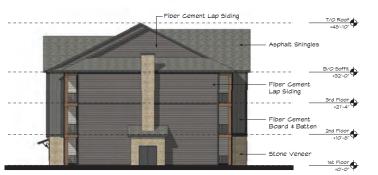

SIDE ELEVATION - BUILDING TYPE D




FRONT ELEVATION - BUILDING TYPE E Scale: 3/32" = 1'-0"







SIDE ELEVATION - BUILDING TYPE E Scale: 3/32" = 1'-0'

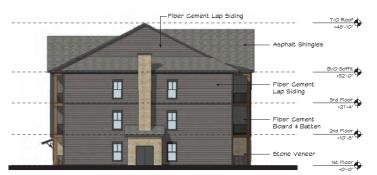

SIDE ELEVATION - BUILDING TYPE E





42.8



