
Conceptual Review Agenda

Schedule for 11/29/18

281 Conference Room A

| Thurso | day, November 29, 201 | <u>18</u> | | | |
|--------|-----------------------|---|---|---------|---------------|
| Time | Project Name | Applicant Info | Project Description | | |
| 10:15 | S Taft Hill Sprint | Charmaine Dregalla 303-507-3471 | This is a request to install a new wireless telecommunications facility on the church property at | Planner | Clark Mapes |
| | Wireless Facility | Charmained1960@gmail.com | 1200 S Taft Hill Road (parcel #9715306970). The proposed facility would be designed as a 50-foot bell | DRC | Brandy BH |
| | CDR180086 | | tower. The equipment would include six radio heads and six antennas. Sprint would lease two areas on the site, one 144 sq ft area for the fenced equipment shelter and | | |
| | CANCELLED | | one 440 sq ft area for the proposed tower. The property is located in the Low Density Residential (RL) zone district and is subject to the Addition of Permitted Use (APU) process. | | |
| 11:00 | Sunshine House | Shelley La Mastra | This is a request to build an early learning center on a vacant lot along Miles House Avenue southwest of the | Planner | Ted Shepard |
| | Early Learning Center | 970-484-8855 slamastra@russellmillsstudios.com | Great Western Railway (parcel #8720467003). The early learning center will have a capacity for 176 children and | DRC | Todd Sullivan |
| | CDR180087 | | 25 staff members. The site currently has 37 parking spaces. Seven spaces will be added for a total of 44 parking spaces. Access to the site is taken from Miles House Avenue to the south. The property is located in the Urban Estate District (UE) zone district and is subject | | |

S Taft Hill Sprint Wireless Facility

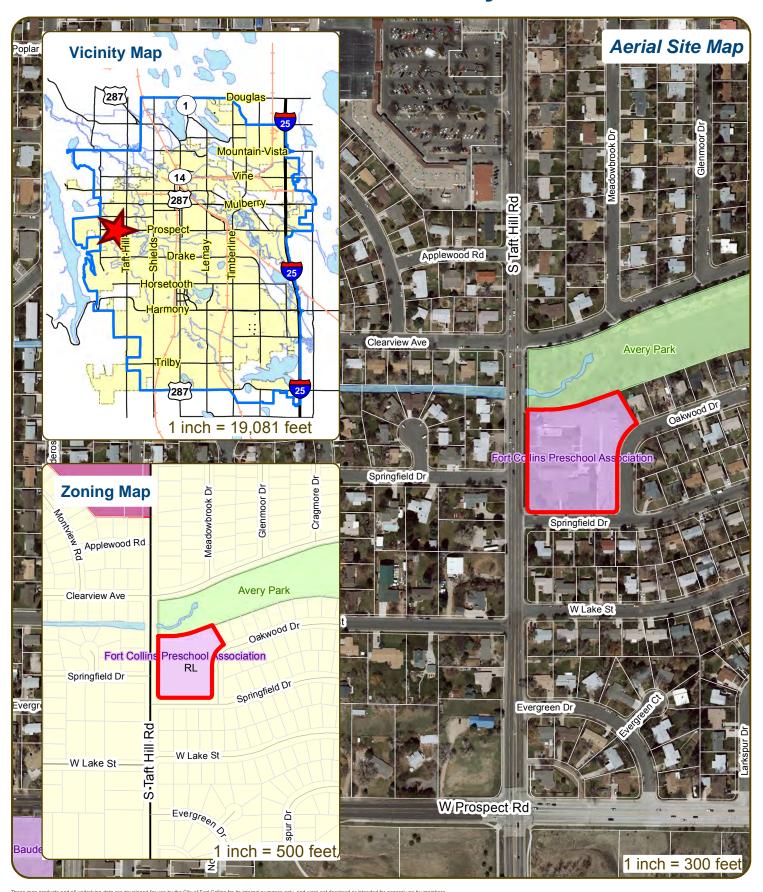

of the public. The City makes no representation or warrenty as to its accuracy, timeleness, and or particular, its accuracy in adeligned green states by memoers of the public. The City makes no representation or warrenty as to its accuracy, timeleness, and in particular, its accuracy in labeling or displaying dimensions, condours, property boundaries, or placement of location of any map features thereon. THE CITY OF FORT COLLINS MAKES NO WARRANTY OF MERCHANTABILITY OR WARRANTY FOR FITNESS OF USE FOR PARTICULAR PURPOSE, EXPRESSED OR IMPLIED, WITH RESPECT TO THESE MAP PRODUCTS OR THE UNDERLYING DATA. Any users of these map products, map applications, or data, accepts same AS IS, WITH ALL FAULTS, and assumes all responsibility of the use thereof, and further covenants and agrees to hold the City harmless from and against all damage, loss, or liability arising from any use of this map product, in consideration of the City's having made this information available. Independent verification of all data contained herein should be obtained by any users of these products, or underlying data. The City discalims, and shall not be held liable for any and all damage, loss, or liability, whether direct, indirect, or consequential, which arises or may arise from these map products or the use thereof by any person or entity.









CONCEPTUAL REVIEW: **APPLICATION**

General Information

All proposed land development projects begin with Conceptual Review. Anyone with a land development idea can schedule a Conceptual Review meeting to get feedback on prospective development ideas. At this stage, the development idea does not need to be finalized or professionally presented. However, a sketch plan or site plan and this application must be submitted to City Staff prior to the Conceptual Review meeting. The more information you are able to provide, the better feedback you are likely to get from the meeting. Generally, Conceptual Review works best after a brief conversation with a representative from the Zoning or Planning Department to first establish compliance with the permitted uses under the applicable zone district. Then a sketch plan or site plan is prepared that allows staff to review and provide comments on the land development aspects of the proposal. Please be aware that any information submitted may be considered a public record, and may be made available to anyone who requests it, including the media. The applicant acknowledges that that they are acting with the owner's consent.

Conceptual Reviews are scheduled on three Thursday mornings per month on a "first come, first served" basis. One 45 meeting is allocated per applicant and only three conceptual reviews are held each Thursday morning. Conceptual Review is a free service. Complete applications and sketch plans must be submitted to City Staff no later than 12:00pm. two Tuesdays prior to the meeting date. Application materials must be e-mailed to currentplanning@fcgov.com. If you do not have access to e-mail, other accommodations can be made upon request.

At Conceptual Review, you will meet with Staff from various City departments, including Community Development and Neighborhood Services (Zoning, Planning, and Development Review Engineering), Light and Power, Stormwater, Water/ Waste Water, Transportation Planning and Poudre Fire Authority. Staff provides the applicant with comments to assist in preparing the detailed formal project application. There is no approval or denial of development proposals associated with Conceptual Review. The applicant will receive the comment letter at the review meeting.

| *BOLDED ITEMS ARE REQUIRED* Contact Name(s) and Role(s) (Please | | |
|--|--|--|
| Business Name (if applicable)Your Mailing Address | | |
| Phone Number | Email Address | |
| Site Address or Description (parcel | # if no address) | |
| Description of Proposal (attach addi | itional sheets if necessary) | |
| | | |
| Proposed Use | Existing Use | |
| Total Building Square Footage | | |
| Age of any Existing Structures Info available on Larimer County's Websit If any structures are 50+ years old, good of | e: http://www.co.larimer.co.us/assesso | r/query/search.cfm structure are required for conceptual. |
| Is your property in a Flood Plain? Info available on FC Maps: http://gisweb.fc | ☐ Yes ☐ No ☐ If yes, then what cgov.com/redirect/default.aspx?layerTr | risk level? neme=Floodplains. |
| Increase in Impervious Area(Approximate amount of additional building | g, pavement, or etc. that will cover exis | S.F. sting bare ground to be added to the site) |
| Suggested items for the Sketch Plan: | | |

Property location and boundaries, surrounding land uses, proposed use(s), existing and proposed improvements (buildings, landscaping, parking/drive areas, water treatment/detention, drainage), existing natural features (water bodies, wetlands, large trees, wildlife, canals, irrigation ditches), utility line locations (if known), photographs (helpful but not required). Things to consider when making a proposal: How does the site drain now? Will it change? If so, what will change?




DN90XCF56

SPRINT NEIGHBORHOOD EXPANSION/FIRST TIME INSTALL PUBLIC RECORD PARCEL NO. 9715306970

> 1200 S TAFT HILL ROAD FORT COLLINS, COLORADO 80521 LARIMER COUNTY

NEW 49'-0" THREE-LEGGED TOWER (OVERALL HEIGHT: 50'-0" A.G.L.) RAWLAND COMMUNICATION SITE



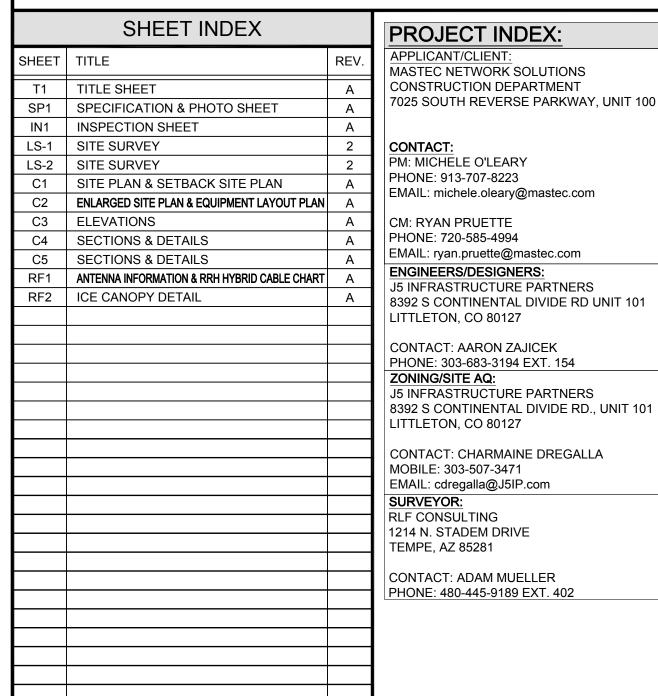

PROJECT INDEX: GENERAL PROJECT NOTES: APPLICANT/CLIENT:

PRIOR TO SUBMITTING A BID, THE CONTRACTOR SHALL FAMILIARIZE HIMSELF/HERSELF WITH THE SCOPE OF WORK AND ALL CONDITIONS AFFECTING MASTEC NETWORK SOLUTIONS CONSTRUCTION DEPARTMENT 7025 SOUTH REVERSE PARKWAY. UNIT 100 CONTRACTOR SHALL VERIFY ALL FIELD CONDITIONS AND DIMENSIONS OF THE JOB

> DOCUMENTS CAN BE ACCOMPLISHED AS SHOWN PRIOR TO COMMENCEMENT OF ALL FIELD MODIFICATIONS BEFORE, DURING, OR AFTER CONSTRUCTION SHALL BE APPROVED IN WRITING BY A VERIZON REPRESENTATIVE

SITE AND CONFIRM THAT WORK AS INDICATED ON THESE CONSTRUCTION

INSTALL ALL EQUIPMENT AND MATERIALS PER THE MANUFACTURER'S RECOMMENDATIONS, UNLESS INDICATED OTHERWISE. NOTIFY VERIZON, IN WRITING, OF ANY MAJOR DISCREPANCIES REGARDING THE

CONTRACT DOCUMENTS, EXISTING CONDITIONS, AND DESIGN INTENT. THE CONTRACTOR SHALL BE RESPONSIBLE FOR OBTAINING CLARIFICATIONS FROM A VERIZON REPRESENTATIVE AND ADJUSTING THE BID ACCORDINGLY. CONTRACTOR SHALL BE SOLELY RESPONSIBLE FOR ALL CONSTRUCTION MEANS, METHODS, TECHNIQUES, SEQUENCES, AND PROCEDURES OF THE WORK UNDER

CONTRACTOR SHALL PROTECT ALL EXISTING IMPROVEMENTS AND FINISHES THAT ARE TO REMAIN. CONTRACTOR SHALL REPAIR ANY DAMAGE THAT MAY OCCUR DURING THE CONSTRUCTION TO THE SATISFACTION OF A VERIZON

THE CONTRACTOR IS RESPONSIBLE FOR RED-LINING THE CONSTRUCTION PLANS TO ILLUSTRATE THE AS-BUILT CONDITION OF THE SITE. FOLLOWING THE FINAL INSPECTION BY VERIZON, THE CONTRACTOR SHALL PROVIDE VERIZON WITH ONE COPY OF ALL RED-LINED DRAWINGS

VERIFY ALL FINAL EQUIPMENT WITH A VERIZON REPRESENTATIVE. ALL EQUIPMEN LAYOUT, SPECS, PERFORMANCE INSTALLATION AND THEIR FINAL LOCATION ARE TO BE APPROVED BY VERIZON. THE CONTRACTOR SHALL BE RESPONSIBLE FOR COORDINATING HIS/HER WORK WITH THE WORK AND CLEARANCES REQUIRED BY OTHERS RELATED TO SAID INSTALLATIONS.

PROJECT INFORMATION:

FORT COLLINS, COLORADO 80521 JURISDICTION CITY OF FORT COLLINS 281 N COLLEGE FORT COLLINS, COLORADO 80524 PLANNING, DEVELOPMMENT & TRANSPORTATION DEPARTMENT PHONE: 970-221-6601

SHEPHERD OF THE HILLS LUTHERAN CHURCH

1200 S TAFT HILL ROAD

PUBLIC RECORD PARCEL NO: 9715306970 LATITUDE: 40.57023°N 105.11471°W

FCC COMPLIANCE: RADIATION FROM THIS FACILITY WILL NOT INTERFERE WITH

OPERATION OF OTHER COMMUNICATION DEVICES.

ADA COMPLIANCE:

THIS FACILITY IS UNMANNED AND NOT FOR HUMAN HABITATION. LANDINGS AND EXITS SHALL COMPLY WITH ALL APPLICABLE BUILDING CODES.

ABBREVIATED LEGAL DESCRIPTION:

TRACT A, MILLER BROTHERS SOUTH FOOTHILLS SUBDIVISION, FIRST FILING, ACCORDING TO THE PLAT FILED MARCH 25, 1960 IN THE CITY OF FORT COLLINS, COUNTY OF LARIMER, STATE OF COLORADO.

PROJECT DESCRIPTION:

THIS PROJECT CONSISTS OF THE FOLLOWING INSTALLATION

- ONE (1) 49'-0" THREE-LEGGED TOWER (DESIGNED BY OTHERS) • ONE (1) NEW ELTEK ECAB MOUNTED ON NEW ELTEK GROUND
- MOUNTING KIT • ONE (1) NEW ELTEK BCAB MOUNTED ON NEW ELTEK GROUND
- MOUNTING KIT • ONE (1) NEW ELTEK GROUND MOUNTING KIT MOUNTED FOR NEW
- **EQUIPMENT CABINETS**
- ONE (1) NEW ELTEK TELCO AND POWER BOX MOUNTED ON NEW GALVANIZED H-FRAME
- NEW WOOD CEDAR FENCE ENCLOSURE WITH GATE
- SIX (6) NEW PANEL ANTENNAS SIX (6) NEW RRH UNITS
- FOUR (4) NEW HYBRID CABLES
- EIGHT (8) NEW 4"Ø PVC CONDUIT PIPES FOR CABLING ONE (1) NEW GENERATOR PLUG







NEW 49'-0" THREE-LEGGED TOWER (OVERALL HEIGHT: 50'-0" A.G.L.) RAWLAND COMMUNICATION SITE

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PROJECT ADDRESS: 1200 S TAFT HILL ROAD FORT COLLINS, COLORADO 80521

LARIMER COUNTY

BUILDING CODE SUMMARY:

X 2015 INTERNATIONAL BUILDING CODE (IBC

X 2015 UNIFORM PLUMBING CODE (W/O CHAP. 13) (UPC). 2015 INTERNATIONAL FUEL GAS CODE (IFGC) 2015 INTERNATIONAL RESIDENTIAL CODE (IRC)

2015 INTERNATIONAL ENERGY CONSERVATION CODE (IECC)

REFER TO BUILDING PERMIT DOCUMENTS AND ALL CONSTRUCTION DOCUMENTS FOR

JSED Code Year / Type: (ORDINANCE)

TITLE SHEET

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|---|--------------|------------------------------------|-----------------|----|----|---------|-----|----|
| | REV | | DESCRIPTION | | | DATE | BY | CH |
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| | | 10/ | 22/2018 8:08 AM | | | _ | 11 | |

GENERAL PROJECT NOTES:

- CONTRACTOR IS RESPONSIBLE FOR ERECTING TEMPORARY BARRICADES AND/OR FENCING TO PROTECT THE SAFETY OF THE PUBLIC DURING CONSTRUCTION. THE CONTRACTOR SHALL REMOVE ALL TEMPORARY BARRIERS AND REPAIR ALL DAMAGE TO PROPERTY ON THE SITE CAUSED BY THIS CONSTRUCTION. THE COST OF REPAIR IS THE CONTRACTOR'S
- RESPONSIBILITY. ALL WORK SHALL BE IN ACCORDANCE WITH APPLICABLE LOCAL, STATE, AND FEDERAL REQUIREMENTS.
- THE CONTRACTOR SHALL BE RESPONSIBLE FOR VERIFICATION OF ALL MEASUREMENTS AT THE
- SITE PRIOR TO ORDERING ANY MATERIALS OR CONDUCTING ANY WORK. EXCESS SOIL MATERIAL AND DEBRIS CAUSED BY THIS CONSTRUCTION SHALL BE REMOVED
- FROM THE SITE AND DISPOSED OF IN A LEGAL MANNER. CONTRACTOR SHALL MAKE ADJUSTMENTS TO GRADING ELEVATIONS AS NECESSARY TO
- ENSURE A SITE FREE OF DRAINAGE PROBLEMS. CONTRACTOR SHALL COORDINATE A CONSTRUCTION LAYDOWN AREA WITH THE PROPERTY OWNER. CONSTRUCTION LAYDOWN AREA SHALL BE FENCED-IN WITH TEMPORARY (45 DAY)
- CONSTRUCTION FENCE. THE TEMPORARY FENCE SHALL BE CONSTRUCTED OF 6' HIGH CHAIN LINK FABRIC AND IS TO BE REMOVED AT THE END OF CONSTRUCTION. LAYDOWN AREA IS TO BE
- RESTORED TO ITS ORIGINAL CONDITION AFTER FENCE REMOVAL. SURVEY INFORMATION SHOWN WAS CREATED FROM RECORD INFORMATION AND DOES NOT
- THESE PLANS DO NOT ADDRESS THE SAFETY AND STABILITY OF THE STRUCTURE DURING ASSEMBLY AND ERECTION, WHICH ARE THE RESPONSIBILITY OF THE ERECTOR, BASED ON THE MEANS AND METHODS CHOSEN BY THE ERECTOR.
- NEW EQUIPMENT COMPOUND SHALL BE COVERED W/ 4" CRUSHED ROCK INSTALLED OVER CLIENT-APPROVED WEED BARRIER MATERIAL (IF APPLICABLE).

GENERAL CONTRACTOR NOTES:

CONSTITUTE A LEGAL BOUNDARY SURVEY.

THE CONTRACTOR SHALL BE RESPONSIBLE FOR THE COMPLETE PROJECT SCOPE OF WORK DEFINED UNDER THE REQUEST FOR PROPOSAL (RFP) FOR THIS PROJECT AND ALL ASSOCIATED ATTACHMENTS AND DOCUMENTS PROVIDED.

THE RFP AND ALL ASSOCIATED DOCUMENTS SHALL DEFINE THE COMPLETE PROJECT SCOPE OF WORK. CONTRACTOR SHALL BE RESPONSIBLE FOR COMPLIANCE WITH ALL DOCUMENTS AND IS SOLELY RESPONSIBLE FOR ALL WORK.

ALL DOCUMENTS INCLUDED WITHIN THE PROJECT REQUEST FOR PROPOSAL ARE REQUIRED FOR THE COMPLETE PROJECT SCOPE OF WORK. THE CONTRACTOR SHALL BE RESPONSIBLE FOR ALL WORK (EQUIPMENT, MATERIAL, INSTALLATION, TESTING, ETC.) INDICATED IN ALL DOCUMENTS. THE RFP, VERIZON WIRELESS NETWORK STANDARDS AND PROJECT ADDENDUMS AND CLARIFICATIONS ARE COMPLEMENTARY TO EACH OTHER. THE FORMAT OF THE SPECIFICATIONS AND DRAWING NUMBERING PER DISCIPLINE IS NOT INTENDED TO IMPLY

SEGREGATION OF SUB CONTRACTOR WORK. CONTRACTOR SHALL ASSIGN ALL SUB CONTRACTOR WORK AND VERIZON WIRELESS WILL NOT ACCEPT ANY CHANGE ORDERS FOR INTERNAL CONTRACTOR WORK ASSIGNMENTS.

CONTRACTOR SHALL BE RESPONSIBLE FOR DISTRIBUTING ALL RFP DOCUMENTS TO THEIR SUB CONTRACTORS. ALL RFP DOCUMENTS ARE REQUIRED TO INDICATE THE PROJECT SCOPE OF WORK. PARTIAL SUB CONTRACTOR DOCUMENT PACKAGES ARE HIGHLY DISCOURAGED.

IN THE EVENT OF A CONFLICT BETWEEN THE DRAWINGS, SPECIFICATIONS, REFERENCED STANDARDS, VERIZON WIRELESS STANDARDS, OR AGREEMENT TERMS AND CONDITIONS THE ARCHITECT/ ENGINEER SHALL BE CONTACTED FOR FORMAL INTERPRETATION OF THE REQUIREMENTS. THE CONTRACTOR SHALL BE DEEMED TO HAVE PROVIDED THE DETAILED AND EXTENSIVE INTERPRETATION. ANY WORK INSTALLED IN CONFLICT WITH THE ARCHITECT/ ENGINEER INTERPRETATIONS SHALL BE CORRECTED BY THE CONTRACTOR AT NO EXPENSE TO VERIZON WIRELESS.

ALL ANTENNAS MUST BE PIM TESTED WITHIN 48 HOURS OF THEM BEING RECEIVED BY THE INSTALLATION CONTRACTOR. THOSE RESULTS MUST BE SENT BACK TO THE VERIZON WIRELESS

- CONSTRUCTION ENGINEER AND EQUIPMENT ENGINEER WITHIN THE SAME 48 HOURS. IF YOU MISS THE 48HR TIMELINE AND THE ANTENNAS DO NOT PASS UPON INSTALLATION, YOUR COMPANY WILL BE CHARGED FOR THE COST OF THE ANTENNAS FOR REPLACEMENT.
- ALL LOADS MUST BE SECURED PROPERLY TO THE VEHICLE OR TRAILER. VERIZON WIRELESS WILL PASS ALONG THE COST OF ANY REPLACEMENTS DUE TO DAMAGE OR LOSS WHETHER IT IS

ANTENNA, MOUNTS & HARDWARE INSTALLATION NOTES:

- CONTRACTOR TO INSTALL ANTENNAS, MOUNTS AND TOWER HARDWARE PER MANUFACTURER'S RECOMMENDATIONS (OR AS REQUIRED BY THE OWNER/PROVIDER).
- ALL BOLTS SHALL BE TIGHTENED PER AISC REQUIREMENTS (SEE STEEL NOTES).
- ANY GALVANIZED SURFACES THAT ARE DAMAGED BY ABRASIONS, CUTS, DRILLING OR FIELD WELDING DURING SHIPPING OR ERECTION SHALL BE TOUCHED-UP WITH TWO COATS OF COLD GALVANIZING COMPOUND MEETING THE REQUIREMENTS OF ASTM A780.
- ANTENNA MOUNTS SHALL NOT BE USED AS A CLIMBING DEVICE. WORKERS SHALL ALWAYS TIE OFF TO AN APPROVED CLIMBING POINT.
- 5. SEE ALSO GENERAL ANTENNA NOTES ON SHEET RF1 (IF APPLICABLE).

INTERIOR SAFETY BOARD SPECIFICATIONS:

CONTRACTOR TO INSTALL A 4'-0"x4'-0"x3/4" PLYWOOD SAFETY BOARD. SAFETY BOARD SHALL BE

EYE WASH KIT, FIRST AID KIT, SAFETY GLOVES, SAFETY APRON & EAR PROTECTION

STRUCTURAL DESIGN CRITERIA:

ALL LOADS DERIVED FROM REQUIREMENTS OF INTERNATIONAL BUILDING CODE 2015, ASCE 7-10, "MINIMUM DESIGN LOADS FOR BUILDINGS AND OTHER STRUCTURES" & ANSI TIA-222-G "STRUCTURAL STANDARD FOR ANTENNA SUPPORTING STRUCTURES AND ANTENNAS". **BUILDING STRUCTURES:**

WIND LOADS: IBC 2015 §1609 & ASCE 7-10 §28.4 (SIMPLIFIED METHOD)

OCCUPANCY CAT. = II; EXPOSURE CAT. = C; IMPORTANCE FACTOR = 1.0

2. SEISMIC LOADS: IBC 2015 §1613 & ASCE 7-10 §12.14 (SIMPLIFIED METHOD) OCCUPANCY CAT. = II; SITE CLASS = D

F = 1.0 (SINGLE-STORY), 1.1 (TWO STORY), 1.2 (THREE STORY)


R = 1.5 (ORDINARY PLAIN CONCRETE SHEARWALLS), 6.5 (LIGHT-FRAMED WALLS W/ WOOD STRUCTURAL PANELS), 4.0 (ORDINARY REINFORCED CONCRETE SHEARWALLS)


COMMUNICATIONS STRUCTURES:

SDS = (2/3) SMS

 $V = F(S_{DS})W$

- WIND LOADS: IBC 2015 §1609, ASCE 7-10 §29.5 & ANSI TIA-222-G V = 115 MPH (3-SEC. GUST)
- $V = 40 \text{ MPH } (\frac{1}{4}\text{" RADIAL ICE})$ STRUCTURE CLASS. = II; EXPOSURE CAT. = C; IMPORTANCE FACTOR = 1.0
- SEISMIC LOADS: IBC 2015 §1613, ASCE 7-10 §15.6.6 & ANSI TIA-222-G STRUCT. CLASS. = II; OCC. CAT. = II; SITE CLASS = D; IMPORTANCE FACTOR = 1.0
- V = Sds(W)I (EQUIVALENT LATERAL FORCE PROCEDURE (METHOD 1))
- $V = \sum Saz(Wz)I$ (EQUIVALENT MODAL ANALYSIS PROCEDURE (METHOD 2))

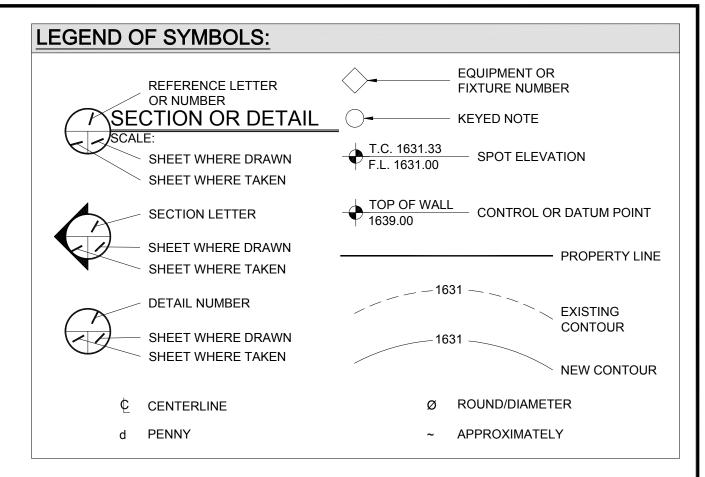


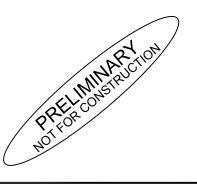





VIEW OF NEW LEASE AREA (LOOKING NORTHEAST)

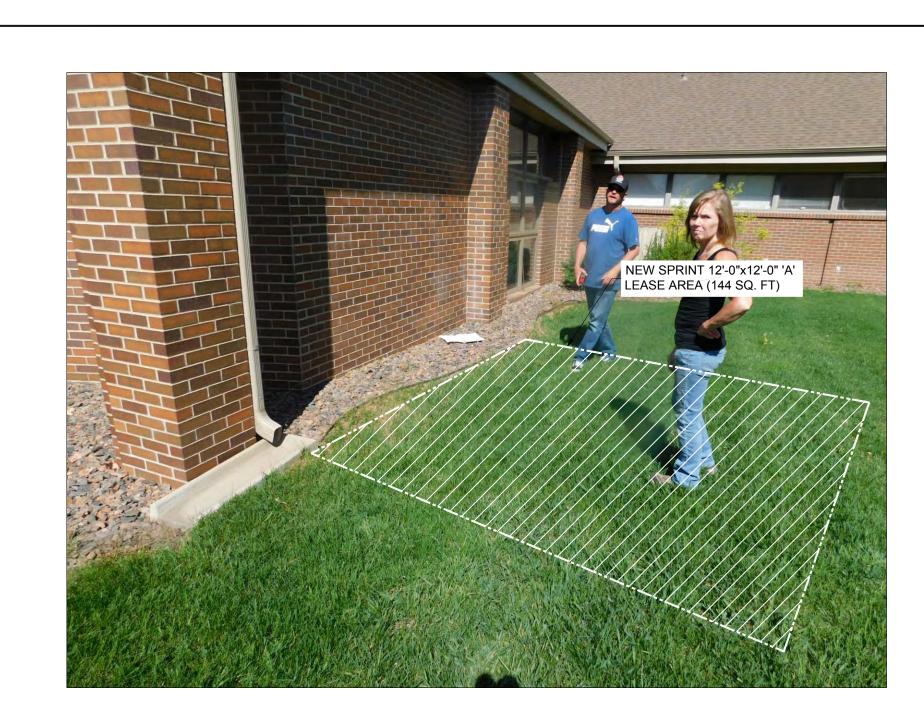

VIEW OF NEW LEASE AREA (LOOKING NORTHEAST)

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AZ - CA - CO - ID - NM - NV - TX - UT

DN90XCF56 NEW 49'-0" THREE-LEGGED TOWER (OVERALL HEIGHT: 50'-0" A.G.L.)

RAWLAND COMMUNICATION SITE PROJECT ADDRESS: 1200 S TAFT HILL ROAD FORT COLLINS, COLORADO 80521

SHEET TITLE:

SPECIFICATION & PHOTO SHEET

LARIMER COUNTY

| REV | DESCRIPTION | | | | DATE | BY | CHK |
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VIEW OF NEW LEASE AREA

(LOOKING NORTH)

| | CONCRI | ETE CON | STRUCTI | ON | |
|-------|---|-------------------------------------|---------------------------------------|--|-----------------------------------|
| REQ'D | ТҮРЕ | CONTINUOUS SPECIAL INSPECTION | PERIODIC SPECIAL INSPECTION | REFERENCED STANDARD | IBC REFERENCE |
| X | 1. INSPECT REINFORCEMENT, INCLUDING PRESTRESSING TENDONS, AND VERIFY PLACEMENT. | - | V | ACI 318: Ch. 20, 25.2, 25.3, 26.6.1-26.6.3 | 1908.4 |
| | 2. REINFORCING BAR WELDING: a. VERIFY WELDABILITY OF REINFORCING BARS OTHER THAN ASTM A706; b. INSPECT SINGLE-PASS FILLET | - | √ √ | AWS D1.4 ACI 318: 26.6.4 | - |
| | WELDS, MAXIMUM $\frac{5}{16}$ " AND c. INSPECT ALL OTHER WELDS. | V | · · · · · · · · · · · · · · · · · · · | | |
| | 3. INSPECT ANCHORS CAST IN CONCRETE. | - | V | ACI 318: 17.8.2 | - |
| | 4. INSPECT ANCHORS POST-INSTALLED IN HARDENED CONCRETE MEMBERS. a. ADHESIVE ANCHORS INSTALLED IN HORIZONTALLY OR UPWARDLY | √ | | ACI 318: 17.8.2.4 | <u>-</u> |
| | INCLINED ORIENTATIONS TO RESIST SUSTAINED TENSION LOADS. b. MECHANICAL ANCHORS AND ADHESIVE ANCHORS NOT DEFINED IN 4.a. | V | √ | ACI 318: 17.8.2 | |
| | 5. VERIFY USE OF REQUIRED DESIGN MIX. | - | V | ACI 318: Ch. 19, 26.4.3, 26.4.4 | 1904.1, 1904.2, 1908.2, 1908.3 |
| | 6. PRIOR TO CONCRETE PLACEMENT, FABRICATE SPECIMENS FOR STRENGTH TESTS, PERFORM SLUMP AND AIR CONTENT TESTS, AND DETERMINE THE TEMPERATURE OF THE CONCRETE. | √ | - | ASTM C172 ASTM C31 ACI 318: 26.4, 26.12 | 1908.10 |
| | 7. INSPECT CONCRETE AND SHORCRETE PLACEMENT TO PROPER APPLICATION TECHNIQUES. | V | - | ACI 318: 26.5 | 1908.6, 1908.7, 1908.8 |
| | 8. VERIFY MAINTENANCE OF SPECIFIED CURING TEMPERATURE AND TECHNIQUES. | - | V | ACI 318: 26.5.3-26.5.5 | 1908.9 |
| | 9. INSPECT PRESTRESSED CONCRETE FOR: a. APPLICATION OF PRESTRESSING | √ | - | ACI 318: 26.10 | _ |
| | FORCES; AND b. GROUTING OF BONDED PRESTRESSING TENDONS. | \checkmark | - | ACI 310. 20.10 | - |
| | 10. INSPECT ERECTION OF PRECAST CONCRETE MEMBERS. | - | √ | ACI 318: Ch. 26.8 | - |
| | 11. VERIFY IN-SITU CONCRETE STRENGTH, PRIOR TO STRESSING OF TENDONS IN POST-TENSIONED CONCRETE AND PRIOR TO REMOVAL OF SHORES AND FORMS FROM BEAMS AND STRUCTURAL SLABS. | - | V | ACI 318: Ch. 26.11.2 | - |
| | 12. INSPECT FORMWORK FOR SHAPE, LOCATION AND DIMENSION OF THE CONCRETE MEMBER BEING FORMED. | - | V | ACI 318: Ch. 26.11.2(b) | - |

| | INSPECTION TASKS PRIOR BOLTING | | | | | | | |
|-------|---|---------------------------------|---|--|--|--|--|--|
| REQ'D | INSPECTION TASKS PRIOR TO BOLTING | OBSERVE ON A RANDOM BASIS | PERFORM FOR EACH BOLTED CONNECTION | APPLICABLE RCSC SPECIFICATION REFERENCES* | | | | |
| х | MANUFACTURERS CERTIFICATIONS AVAILABLE FOR FASTENER MATERIALS. | V | - | 2.1, 9.1 | | | | |
| | FASTENERS MARKED IN ACCORDANCE WITH ASTM REQUIREMENTS. | √ | - | FIGURE C-2.1, 9.1 (ALSO SEE ASTM STANDARDS) | | | | |
| | PROPER FASTENERS SELECTED FOR THE JOINT DETAIL (GRADE, TYPE, BOLT LENGTH IF THREADS TO BE EXCLUDED FROM SHEAR PLATE) | V | - | 2.3.2, 2.7.2, 9.1 | | | | |
| | PROPER BOLTING PROCEDURE SELECTED FOR JOINT DETAIL | V | - | 4, 8 | | | | |
| | CONNECTION ELEMENTS, INCLUDING THE APPROPRIATE FAYING SURFACE CONDITION AND HOLE PREPARATION, IF SPECIFIED, MEET APPLICABLE REQUIREMENTS, | V | - | 3, 9.1, 9.3 | | | | |
| | PRE-INSTALLATION VERIFICATION TESTING BY INSTALLATION PERSONNEL OBSERVED AND DOCUMENTED FOR FASTENER ASSEMBLIES AND METHODS USED. | - | 1 | 7, 9.2 | | | | |
| | PROPER STORAGE PROVIDED FOR BOLTS, NUTS, WASHERS, AND FASTENER COMPONENTS. *RCSC (2009) | V | - | 2.2, 8, 9.1 | | | | |

| <u>TABLE N5.6-2</u> | | | | | | | | | |
|---------------------|---|---------------------------------|---|--|--|--|--|--|--|
| | INSPECTION TASKS DURING BOLTING | | | | | | | | |
| REQ'D | INSPECTION TASKS DURING TO BOLTING | OBSERVE ON A RANDOM BASIS | PERFORM FOR EACH BOLTED CONNECTION | APPLICABLE RCSC SPECIFICATION REFERENCES* | | | | | |
| X | FASTENER ASSEMBLIES, OF SUITABLE CONDITION, PLACED IN ALL HOLES AND WASHERS (IF REQUIRED) ARE POSITIONED AS REQUIRED. | V | - | 8.1, 9.1 | | | | | |
| | JOINT BROUGHT TO THE SNUG TIGHT CONDITION PRIOR TO THE PRETENSIONING OPERATION. | √ | - | 8.1, 9.1 | | | | | |
| | FASTENER COMPONENT NOT TURNED BE THE WRENCH PREVENTED FROM ROTATING. | √ | - | 8.2, 9.2 | | | | | |
| | FASTENERS ARE PRETENSIONED IN ACCORDANCE WITH A METHOD APPROVED BY RCSC AND PROGRESSING SYSTEMATICALLY FROM MOST RIGID POINT TOWARD FREE EDGES. | V | - | 8.2, 9.2 | | | | | |
| | *RCSC (2009) | | · | | | | | | |

| | <u>TABLE N5.6-3</u> INSPECTION TASKS AFTER BOLTING | | | | | | |
|-------|---|---------------------------------|------------------------------------|--|--|--|--|
| REQ'D | INSPECTION TASKS AFTER BOLTING | OBSERVE ON A RANDOM BASIS | PERFORM FOR EACH BOLTED CONNECTION | APPLICABLE RCSC SPECIFICATION REFERENCES* | | | |
| Х | DOCUMENT ACCEPTANCE OR REJECTION OF BOLTED CONNECTIONS. | - | √ | NOT ADDRESSED BY RCSC | | | |
| | *RCSC (2009) | | | | | | |

| | TABLE | N5.4- | <u>1</u> | |
|-------|---|------------------------------------|---|---|
| | INSPECTION TASKS | PRIOR | TO WE | <u>LDING</u> |
| REQ'D | INSPECTION TASKS PRIOR TO WELDING | OBSERVE ON A RANDOM BASIS | PERFORM FOR EACH WELDED JOINT OR MEMBER | AWS D1.1/D1.1M REFERENCES |
| X | WELDING PROCEDURE SPECIFICATIONS (WPSs) AVAILABLE | - | √ | 6.3 |
| | MANUFACTURER CERTIFICATIONS FOR WELDING CONSUMABLES AVAILABLE | - | √ | 6.2 |
| | MATERIAL IDENTIFICATION (TYPE/GRADE) | \checkmark | - | 6.2 |
| | WELDER IDENTIFICATION SYSTEM | √ | - | 6.4 (WELDER QUALIFICATION) (IDENTIFICATION SYSTEM NOT REQUIRED BY AWS D1.1/D1.1M) |
| | FIT-UP OF GROOVE WELDS (INCLUDING JOINT GEOMETRY) JOINT PREPARATION DIMENSIONS (ALIGNMENT, ROOT OPENING, ROOT FACE, BEVEL) CLEANLINESS (CONDITION OF STEEL SURFACES) TACKING (TACK WELD QUALITY AND LOCATION) BACKING TYPE AND FIT (IF APPLICABLE) | √ | - | 6.5.2 5.22 5.15 5.18 5.10, 5.22.1.1 |
| | CONFIGURATION AND FINISH OF ACCESS HOLES | √ | - | 6.5.2, 5.17 (ALSO SEE SECTION J1.6) |
| | FIT-UP OF FILLET WELDS DIMENSIONS (ALIGNMENT, GAPS AT ROOT) CLEANLINESS (CONDITION OF STEEL SURFACES) TACKING (TACK WELD QUALITY AND LOCATION) | V | - | 5.22.1 5.15 5.18 |
| | CHECK WELDING EQUIPMENT | √ | - | 6.2, 5.11 |

| | <u>INSPECTION TASK</u> | | PERFORM | |
|-------|--|------------------------------------|--|--|
| REQ'D | INSPECTION TASKS DURING WELDING | OBSERVE ON A RANDOM BASIS | FOR EACH WELDED JOINT OR MEMBER | AWS D1.1/D1.1M REFERENCES* |
| Х | USE OF QUALIFIED WELDERS | √ | - | 6.4 |
| | CONTROL AND HANDLING OF WELDING CONSUMABLES PACKAGING EXPOSURE CONTROL | V | - | 6.2 5.3.1 5.3.2 (FOR SMAW), 5.3.3 (FOR SAW) |
| | NO WELDING OVER CRACKED TACK WELDS | √ | - | 5.18 |
| | ENVIRONMENTAL CONDITIONS · WIND SPEED WITHIN LIMITS · PRECIPITATION AND TEMPERATURE | V | - | 5.12.1 5.12.2 |
| | WPS FOLLOWED SETTINGS ON WELDING EQUIPMENT TRAVEL SPEED SELECTED WELDING MATERIALS SHIELDING GAS TYPE/FLOW RATE PREHEAT APPLIED INTERPASS TEMPERATURE MAINTAINED (MIN./MAX.) PROPER POSITION (F, V, H, OH) | √ | - | 6.3.3, 6.5.2, 5.5, 5.2.1 5.6, 5.7 |
| | WELDING TECHNIQUES INTERPASS AND FINAL CLEANING EACH PASS WITHIN PROFILE LIMITATIONS EACH PASS MEETS QUALITY REQUIREMENTS | V | - | 6.5.2, 6.5.3, 5.24, 5.30.1 |

| EQ'D | INSPECTION TASKS AFTER WELDING | OBSERVE ON A RANDOM BASIS | PERFORM FOR EACH WELDED JOINT OR MEMBER | AWS D1.1/D1.1M REFERENCES |
|------|---|------------------------------------|---|---|
| X | WELDS CLEANED | \checkmark | - | 5.30.1 |
| | SIZE AND LENGTH AND LOCATION OF WELDS | - | √ | 6.5.1 |
| | WELDS MEET VISUAL ACCEPTANCE CRITERIA CRACK PROHIBITION WELD/BASE-METAL FUSION CRATER CROSS SECTION WELD PROFILES WELD SIZE UNDERCUT POROSITY | - | V | 6.5.3 TABLE 6.1(1) TABLE 6.1(2) TABLE 6.1(3) TABLE 6.1(4), 5.24 TABLE 6.1(6) TABLE 6.1(7) TABLE 6.1(8) |
| | ARC STRIKES | - | V | 5.29 |
| | k-AREA* | - | √ | NOT ADDRESSED IN AWS |
| | BACKING REMOVED AND WELD TABS REMOVED (IF REQUIRED) | - | √ | 5.10, 5.31 |
| | REPAIR ACTIVITIES | - | √ | 6.5.3, 5.26 |
| | DOCUMENT ACCEPTANCE OR REJECTION OF WELDED JOINT OR MEMBER | - | √ | 6.5.4, 6.5.5 |

SPECIAL INSPECTION COORDINATION:

- IF STEEL FABRICATOR IS STATE APPROVED, STEEL SPECIAL INSPECTIONS ARE NOT REQUIRED.

 ALL SPECIAL INSPECTIONS MUST BE PERFORMED BY A QUALIFIED INSPECTOR.
- ALL INSPECTION REPORTS SHALL BE ORGANIZED INTO A CONCISE DOCUMENT AND DELIVERED TO THE ENGINEER OF RECORD FOR APPROVAL.


- SPECIAL INSPECTION COORDINATIONS:
 - SPECIAL INSPECTIONS APPLICABLE TO CONCRETE CONSTRUCTION ARE ONLY REQUIRED FOR TOWER FOUNDATION. SPECIAL INSPECTION ARE NOT REQUIRED FOR SHELTER FOUNDATIONS OR GENERATOR PAD FOUNDATIONS.

 MARTINEZ ASSOCIATES, INC.

 14828 WEST 6TH AVENUE, UNIT 9B
 - GOLDEN, COLORADO 80401
- CONTACT: JERE STRICKLAND, P.E. PHONE: 303-459-2216

PIER FOUNDATIONS (IBC TABLE 1704.9):

| <u> </u> | TOUNDATIONS (IDC TABLE 1704.5). | | | |
|----------|--|------------|----------|---------------------|
| REQ'D | VERIFICATION & INSPECTION | CONTINUOUS | PERIODIC | REFERENCED STANDARD |
| Х | 1. OBSERVE DRILLING OPERATIONS AND MAINTAIN COMPLETE AND ACCURATE RECORDS FOR EACH PIER. | ~ | - | - |
| | 2. VERIFY PLACEMENT LOCATIONS AND PLUMBNESS, CONFIRM PIER DIAMETERS, BELL DIAMETERS (IF APPLICABLE), LENGTHS, EMBEDMENT INTO BEDROCK (IF APPLICABLE) AND ADEQUATE END BEARING STRATA CAPACITY. | V | - | - |

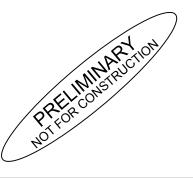

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ESIGNED FOR:



SIGNED BY:



PROJECT NAME:

DN90XCF56

NEW 49'-0" THREE-LEGGED TOWER

(OVERALL HEIGHT: 50'-0" A.G.L.)

RAWLAND COMMUNICATION SITE

PROJECT ADDRESS:

1200 S TAFT HILL ROAD FORT COLLINS, COLORADO 80521 LARIMER COUNTY

SHEET TITLE:

INSPECTION SHEET

| REV | | DESCRIPTION | | | DATE | BY | СНІ |
|------------|------------------------------------|-------------|---------------|----|---------|-----|-----|
| Α | PRELIMINARY - NOT FOR CONSTRUCTION | | | 10 |)/22/18 | MKR | - |
| | | | | | | | |
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| | | | | | | | |
| SAVE DATE: | | SHEET NUMBE | SHEET NUMBER: | | N I A | | |
| | 10/ | | | | N1 | | |

SURVEYOR NOTES

- 1. ALL TITLE INFORMATION IS BASED UPON A COMMITMENT FOR TITLE INSURANCE PREPARED BY FIRST AMERICAN TITLE INSURANCE COMPANY, ORDER NO.: NCS-907743-CO EFFECTIVE DATE: 05/29/2018.
- SURVEYOR HAS NOT PERFORMED A SEARCH OF PUBLIC RECORDS TO DETERMINE ANY DEFECT IN TITLE.
- THE BOUNDARY SHOWN HEREON IS PLOTTED FROM RECORD INFORMATION AND DOES NOT CONSTITUTE A BOUNDARY SURVEY OF THE PROPERTY.
- SURVEYOR DOES NOT GUARANTEE THAT ALL UTILITIES ARE SHOWN OR THEIR LOCATIONS. IT IS THE RESPONSIBILITY OF THE CONTRACTOR AND DEVELOPER TO CONTACT BLUE STAKE AND ANY OTHER INVOLVED AGENCIES TO LOCATE ALL UTILITIES PRIOR TO CONSTRUCTION. REMOVAL, RELOCATION AND/ OR REPLACEMENT IS THE RESPONSIBILITY OF THE CONTRACTOR.

LESSOR'S LEGAL DESCRIPTION

TRACT A, MILLER BROTHERS SOUTH FOOTHILLS SUBDIVISION, FIRST FILING, ACCORDING TO THE PLAT FILED MARCH 25, 1960 IN THE CITY OF FORT COLLINS, COUNTY OF LARIMER, STATE OF COLORADO.


SCHEDULE B EXCEPTIONS


(7.) EASEMENTS, NOTES, COVENANTS, RESTRICTIONS AND RIGHTS-OF-WAY AS SHOWN ON THE PLAT OF MILLER BROTHERS SOUTH FOOTHILLS SUBDIVISION FIRST FILING, RECORDED JANUARY 14, 1960 IN PLAT BOOK M AT PAGE 66.

ITEMS 1 THRU 6, AND 8 THRU 9 OF THE CLIENT PROVIDED TITLE REPORT DO NOT CONTAIN GRAPHICALLY PLOTTABLE EASEMENTS, SETBACKS, RESTRICTIONS OR OTHER ENCUMBRANCES. THE SURVEYOR CANNOT GUARANTEE THAT NON-PLOTTABLE ENCUMBRANCES DO NOT EXIST THAT MAY AFFECT THE SUBJECT LEASED PREMISES.

LEGEND

- FOUND REBAR AS NOTED
- AIR CONDITIONING UNIT ET ELECTRICAL TRANSFORMER
- ▼ TELEPHONE PEDESTAL
- GAS METER WM WATER METER
- ∞ BACKFLOW PREVENTER
- STORM DRAIN GRATE
- DECIDUOUS TREE
- × 5280.00 NG SPOT ELEVATION
- PROPERTY LINE — — — — EASEMENT LINE
- WOOD OR IRON FENCE
- E E E U/G ELECTRIC LINE — T — T — U/G TELECOMMUNICATION LINE
- ——G——G—— U/G GAS LINE
- ——SD——SD——SD——STORM SEWER LINE D/W DRIVEWAY

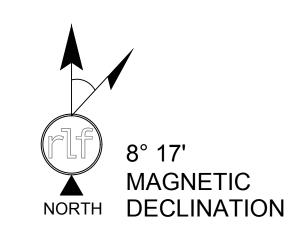

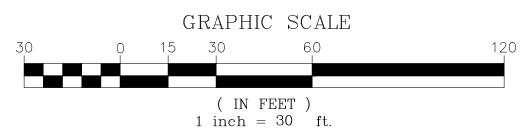

PROJECT META DATA

- ELEVATIONS SHOWN HEREON ARE REPRESENTED IN NORTH AMERICAN VERTICAL DATUM OF 1988 (NAVD88) ESTABLISHED FROM GPS DERIVED ELLIPSOID HEIGHTS, APPLYING GEOID 12B SEPARATIONS CONSTRAINING TO NGS CORS STATIONS PROVIDED IN THE "ONLINE POSITIONING USER SERVICE" (OPUS) SOLUTION FOR THIS SPECIFIC
- BEARINGS SHOWED HEREON ARE BASED UPON U.S. STATE PLANE NAD83 COORDINATE SYSTEM COLORADO STATE PLANE COORDINATE ZONE NORTH, DETERMINED BY GPS OBSERVATIONS.

FOUND REBAR W/

5071.8 NG_

- 10' SIGN

GROUND

SURVEY DETAIL

SHEET LS-2

RED PLASTIC CAP "ILLEGIBLE"

ASPHALT PARKING LOT

- PLAYGROUND -

AREA

5072.4 NG

(E) WOOD FENCE

__5095.1 PEAK_

SPRINGFIELD DRIVE (60' ROW)

5082.1 ROOF_

3. FIELD WORK FOR THIS PROJECT WAS PERFORMED ON 09/07/2018.

FLOOD ZONE DESIGNATION

7 10' UTILITY - EASEMENT

LESSORS PARCEL LINE


THE PROPOSED LEASE PREMISES SHOWN HEREON APPEAR TO BE WITHIN FLOOD ZONE "X" AS DELINEATED ON THE FEDERAL EMERGENCY MANAGEMENT AGENCY FIRM MAP NO. 08069C0978G DATED 05/02/2012.

FOUND REBAR W/

√ 6' UTILITY _/EASEMENT

RED PLASTIC CAP "ILLEGIBLE"

FLOOD ZONE "X" IS DEFINED AS: AREAS DETERMINED TO BE OUTSIDE 500-YEAR FLOODPLAIN; DETERMINED TO BE OUTSIDE THE 1% AND 0.2% ANNUAL CHANCE FLOODPLAINS.

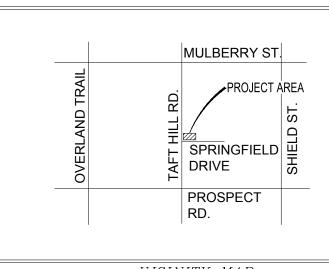

<u>VICINITY MAP</u> N. T. S.





| FIELD BY: | JAS |
|-------------|-----|
| DRAWN BY: | ВМН |
| CHECKED BY: | RLF |

| REVISIONS | | | | | |
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| | | | | | |
| 2 | 10/21/18 | ADD EASEMENTS | | | |
| 1 | 09/21/18 | PRELIMINARY | | | |
| NO. | DATE | DESCRIPTION | | | |



1214 N. STADEM DR. • TEMPE AZ 85281 www.rlfconsulting.com • 480-445-9189



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PROJECT No.

18003019

SITE NAME: DX90XCF56

SITE ADDRESS:

1200 S. TAFT HILL RD.

FORT COLLINS, CO 80526

SHEET TITLE:

TOPOGRAPHIC SURVEY

SHEET NO.

LS-1

REVISION:

ASPHALT PARKING LOT __5109.2 ROOF_ 5094.9 PEAK_ __5113.1 PEAK__ 5109.1 ROOF / 5103.3 ROOF PARCEL LINE SHÉPARD OF THE HILLS APN: 9715306970 __5072.2 NG_ ___5073.0 NG _ 250.00' 🖆 - PARENT PARCEL LINE

ACCESS/UTILITY EASEMENT LEGAL DESCRIPTION

LEGEND

FOUND REBAR AS NOTED

AIR CONDITIONING UNIT

▼ TELEPHONE PEDESTAL

[®] BACKFLOW PREVENTER

WM WATER METER

WATER MANHOLESTORM DRAIN GRATE

DECIDUOUS TREE

6 HANDICAP

× 5280.00 NG SPOT ELEVATION

– – PROPERTY LINE

—— T ——— T ——— T —— U/G TELECOMMUNICATION LINE

DRIVEWAY

— — — — EASEMENT LINE

— E — E — E — U/G ELECTRIC LINE

——SD——SD——SD——STORM SEWER LINE

——G——G——G—— U/G GAS LINE

WOOD OR IRON FENCE

ET ELECTRICAL TRANSFORMER

A PORTION OF LAND WITHIN TRACT A OF MILLER BROTHERS SOUTH FOOTHILLS SUBDIVISION, ACCORDING TO THE PLAT FILED MARCH 25, 1960, LARIMER COUNTY, COLORADO, DESCRIBED AS FOLLOWS:

COMMENCING AT THE NORTHWEST CORNER OF SAID TRACT A, THENCE SOUTH 00°01'00" WEST 227.76 FEET ALONG THE WEST PROPERTY LINE OF TRACT A TO THE POINT OF BEGINNING;

THENCE DEPARTING SAID WEST PROPERTY LINE NORTH 90°00'00" EAST 38.62 FEET; THENCE NORTH 00°00'00" EAST 7.00 FEET; THENCE NORTH 90°00'00" EAST 5.00 FEET; THENCE SOUTH 00°00'00" EAST 12.00 FEET; THENCE NORTH 90°00'00" EAST 12.00 FEET; THENCE SOUTH 00°00'00" EAST 12.00 FEET; THENCE NORTH 90°00'00" WEST 50.63 FEET TO SAID WEST PROPERTY LINE; THENCE NORTH 00°01'00" EAST 17.00 ALONG SAID WEST PROPERTY LINE TO THE POINT OF BEGINNING.

LEASE AREA 1 LEGAL DESCRIPTION

A PORTION OF LAND WITHIN TRACT A OF MILLER BROTHERS SOUTH FOOTHILLS SUBDIVISION, ACCORDING TO THE PLAT FILED MARCH 25, 1960, LARIMER COUNTY, COLORADO, DESCRIBED AS FOLLOWS:

COMMENCING AT THE NORTHWEST CORNER OF SAID TRACT A, THENCE SOUTH 00°01'00" WEST 227.76 FEET ALONG THE WEST PROPERTY LINE OF TRACT A; THENCE DEPARTING SAID PROPERTY LINE NORTH 90°00'00" EAST 38.62 FEET; THENCE NORTH 00°00'00" EAST 7.00 FEET; THENCE NORTH 90°00'00" EAST 5.00 FEET TO THE POINT OF BEGINNING;

THENCE NORTH 90°00'00" EAST 12.00 FEET; THENCE SOUTH 00°00'00" EAST 12.00 FEET; THENCE NORTH 90°00'00" WEST 12.00 FEET; THENCE NORTH 00°00'00" EAST 12.00 FEET TO THE POINT OF BEGINNING.

LEASE AREA 2 LEGAL DESCRIPTION

A PORTION OF LAND WITHIN TRACT A OF MILLER BROTHERS SOUTH FOOTHILLS SUBDIVISION, ACCORDING TO THE PLAT FILED MARCH 25, 1960, LARIMER COUNTY, COLORADO, DESCRIBED AS FOLLOWS:

COMMENCING AT THE NORTHWEST CORNER OF SAID TRACT A, THENCE SOUTH 00°01'00" WEST 244.76 FEET ALONG THE WEST PROPERTY LINE OF TRACT A; THENCE DEPARTING SAID PROPERTY LINE NORTH 90°00'00" EAST 50.63 FEET TO THE POINT OF BEGINNING;

THENCE NORTH 90°00'00" EAST 22.00 FEET; THENCE SOUTH 00°00'00" EAST 20.00 FEET; THENCE NORTH 90°00'00" WEST 22.00 FEET; THENCE NORTH 00°00'00" EAST 20.00 FEET TO THE POINT OF BEGINNING.





| | |
|-------------|-----|
| FIELD BY: | JAS |
| DRAWN BY: | ВМН |
| CHECKED BY: | RLF |

| REVISIONS | | | | |
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| | | | | |
| 2 | 10/21/18 | ADD EASEMENTS | | |
| 1 | 09/21/18 | PRELIMINARY | | |
| NO. | DATE | DESCRIPTION | | |



LAND SURVEY • MAPPING SOLUTIONS
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PROJECT No.

18003019

SITE NAME: DX90XCF56

SITE ADDRESS:

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FORT COLLINS, CO 80526


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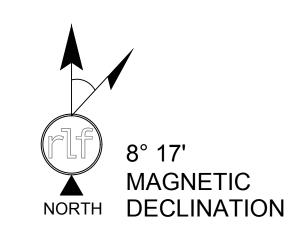
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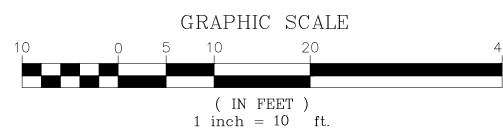
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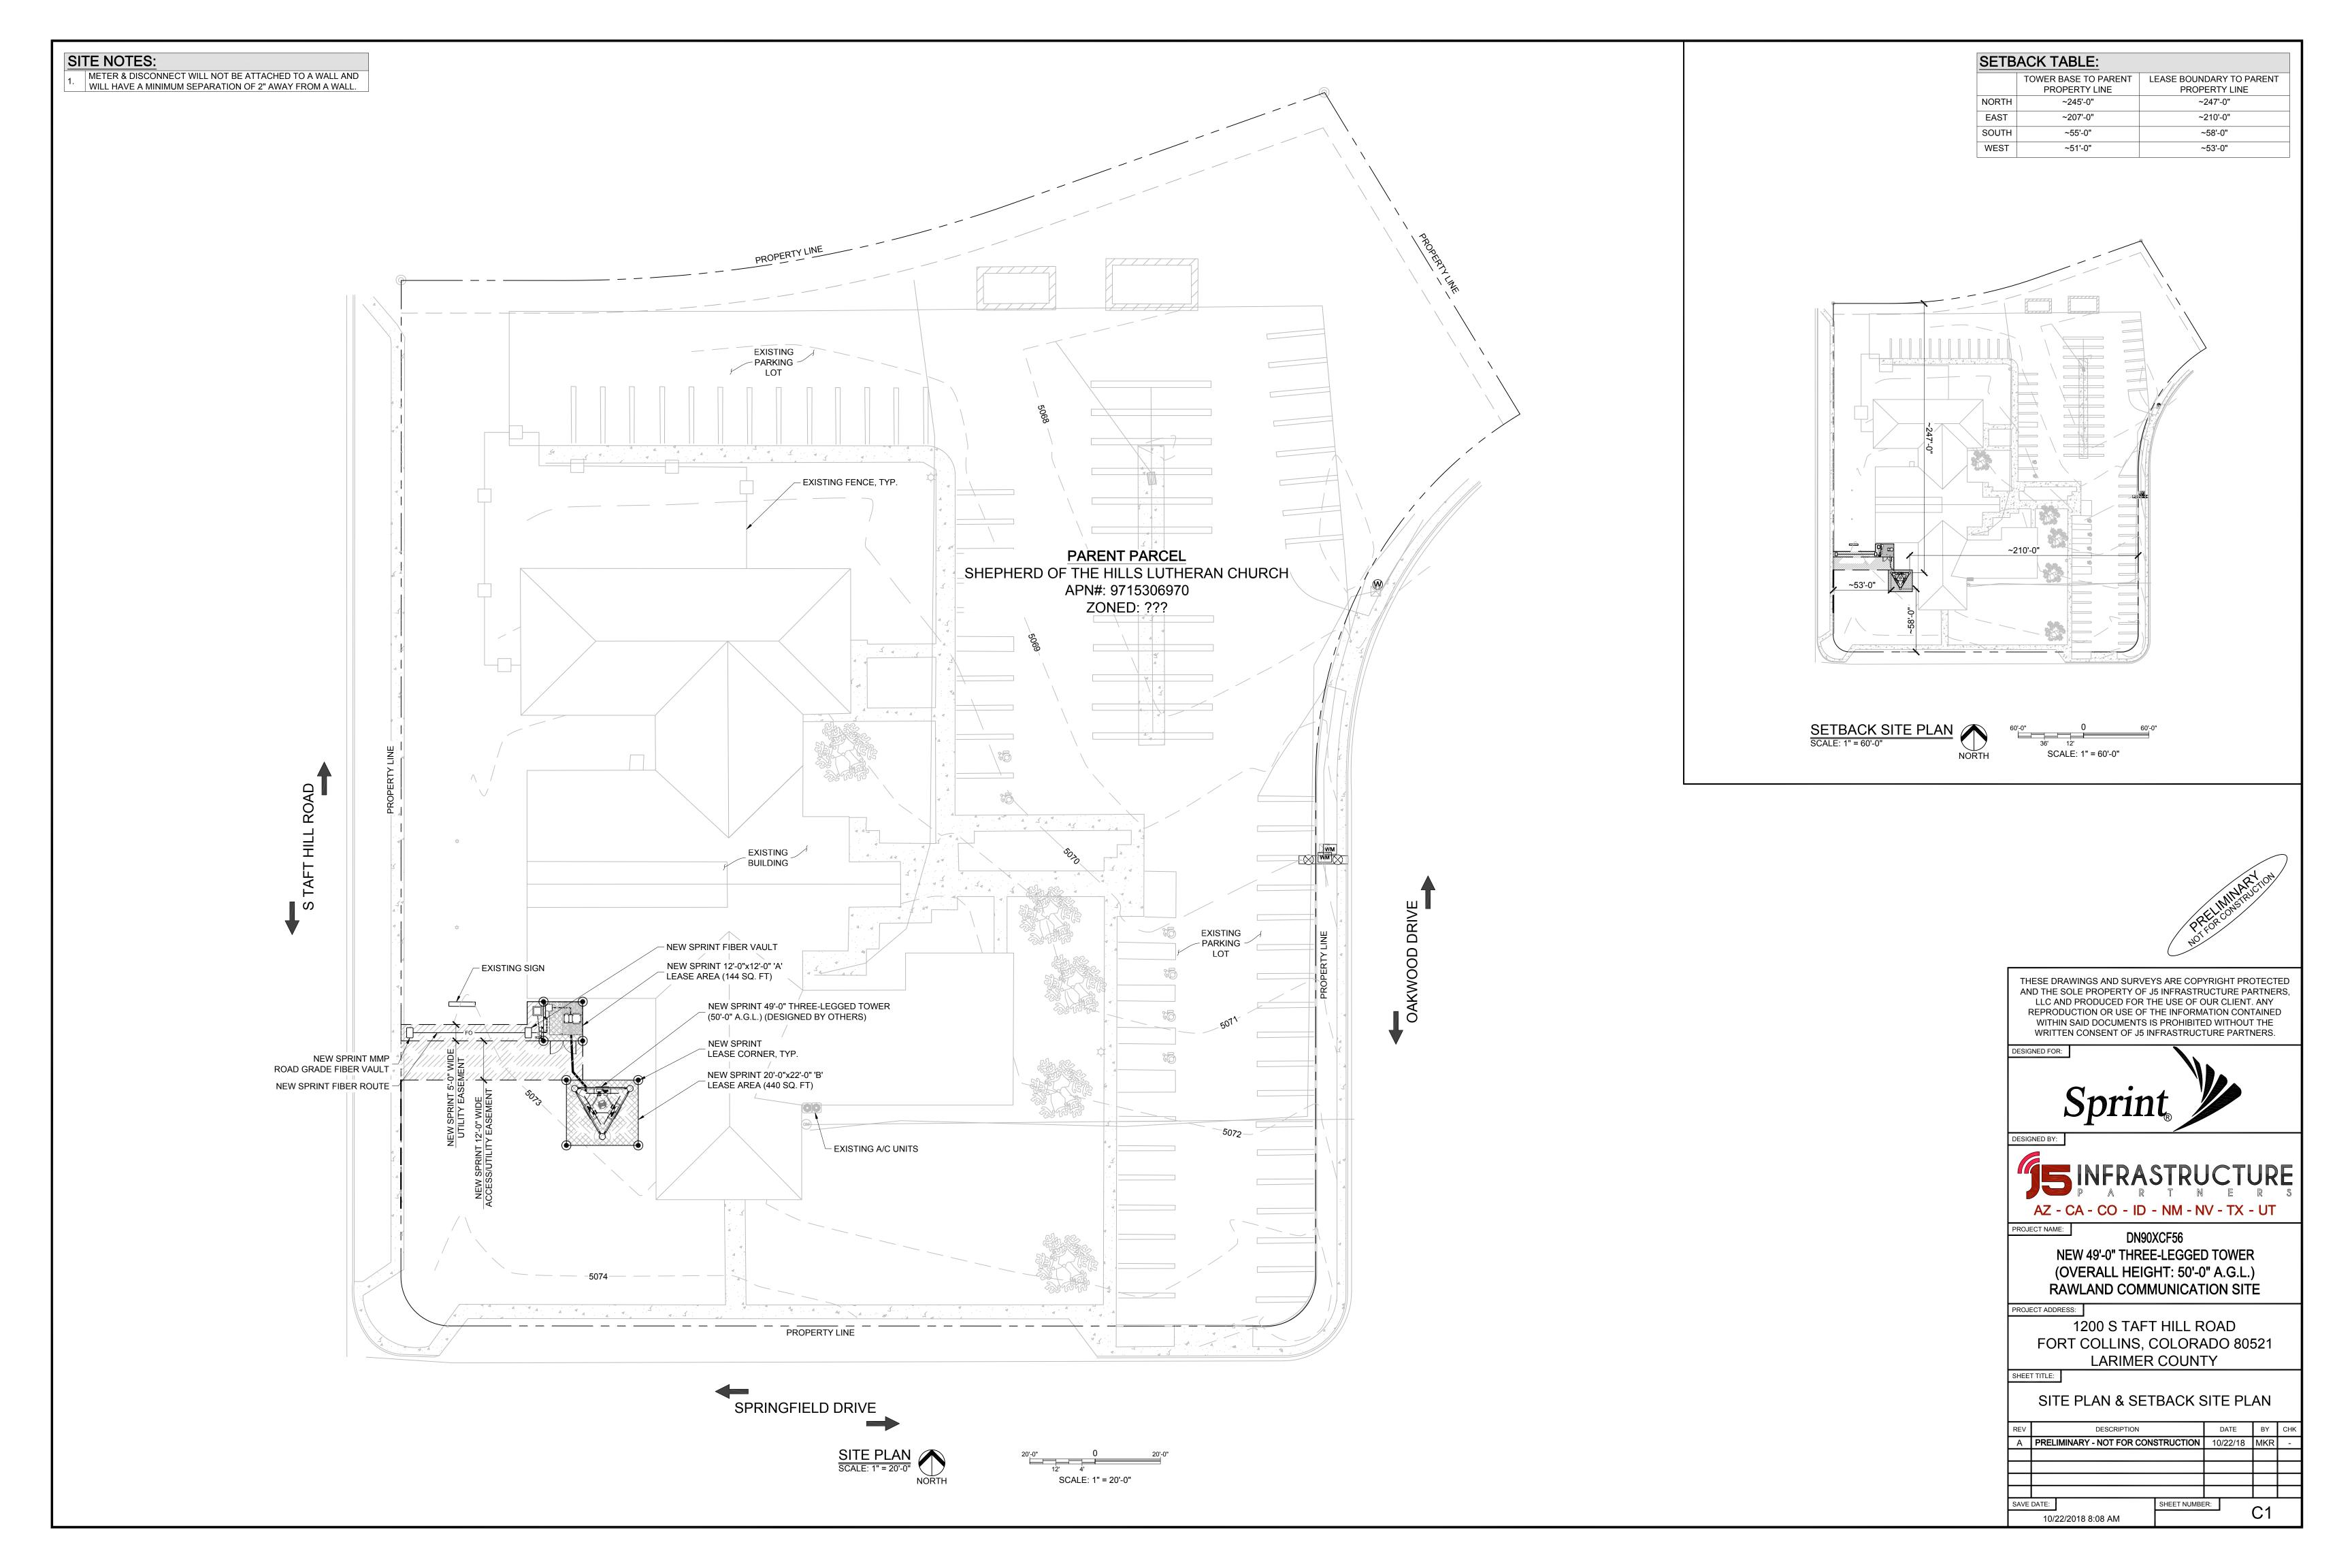
LS-2


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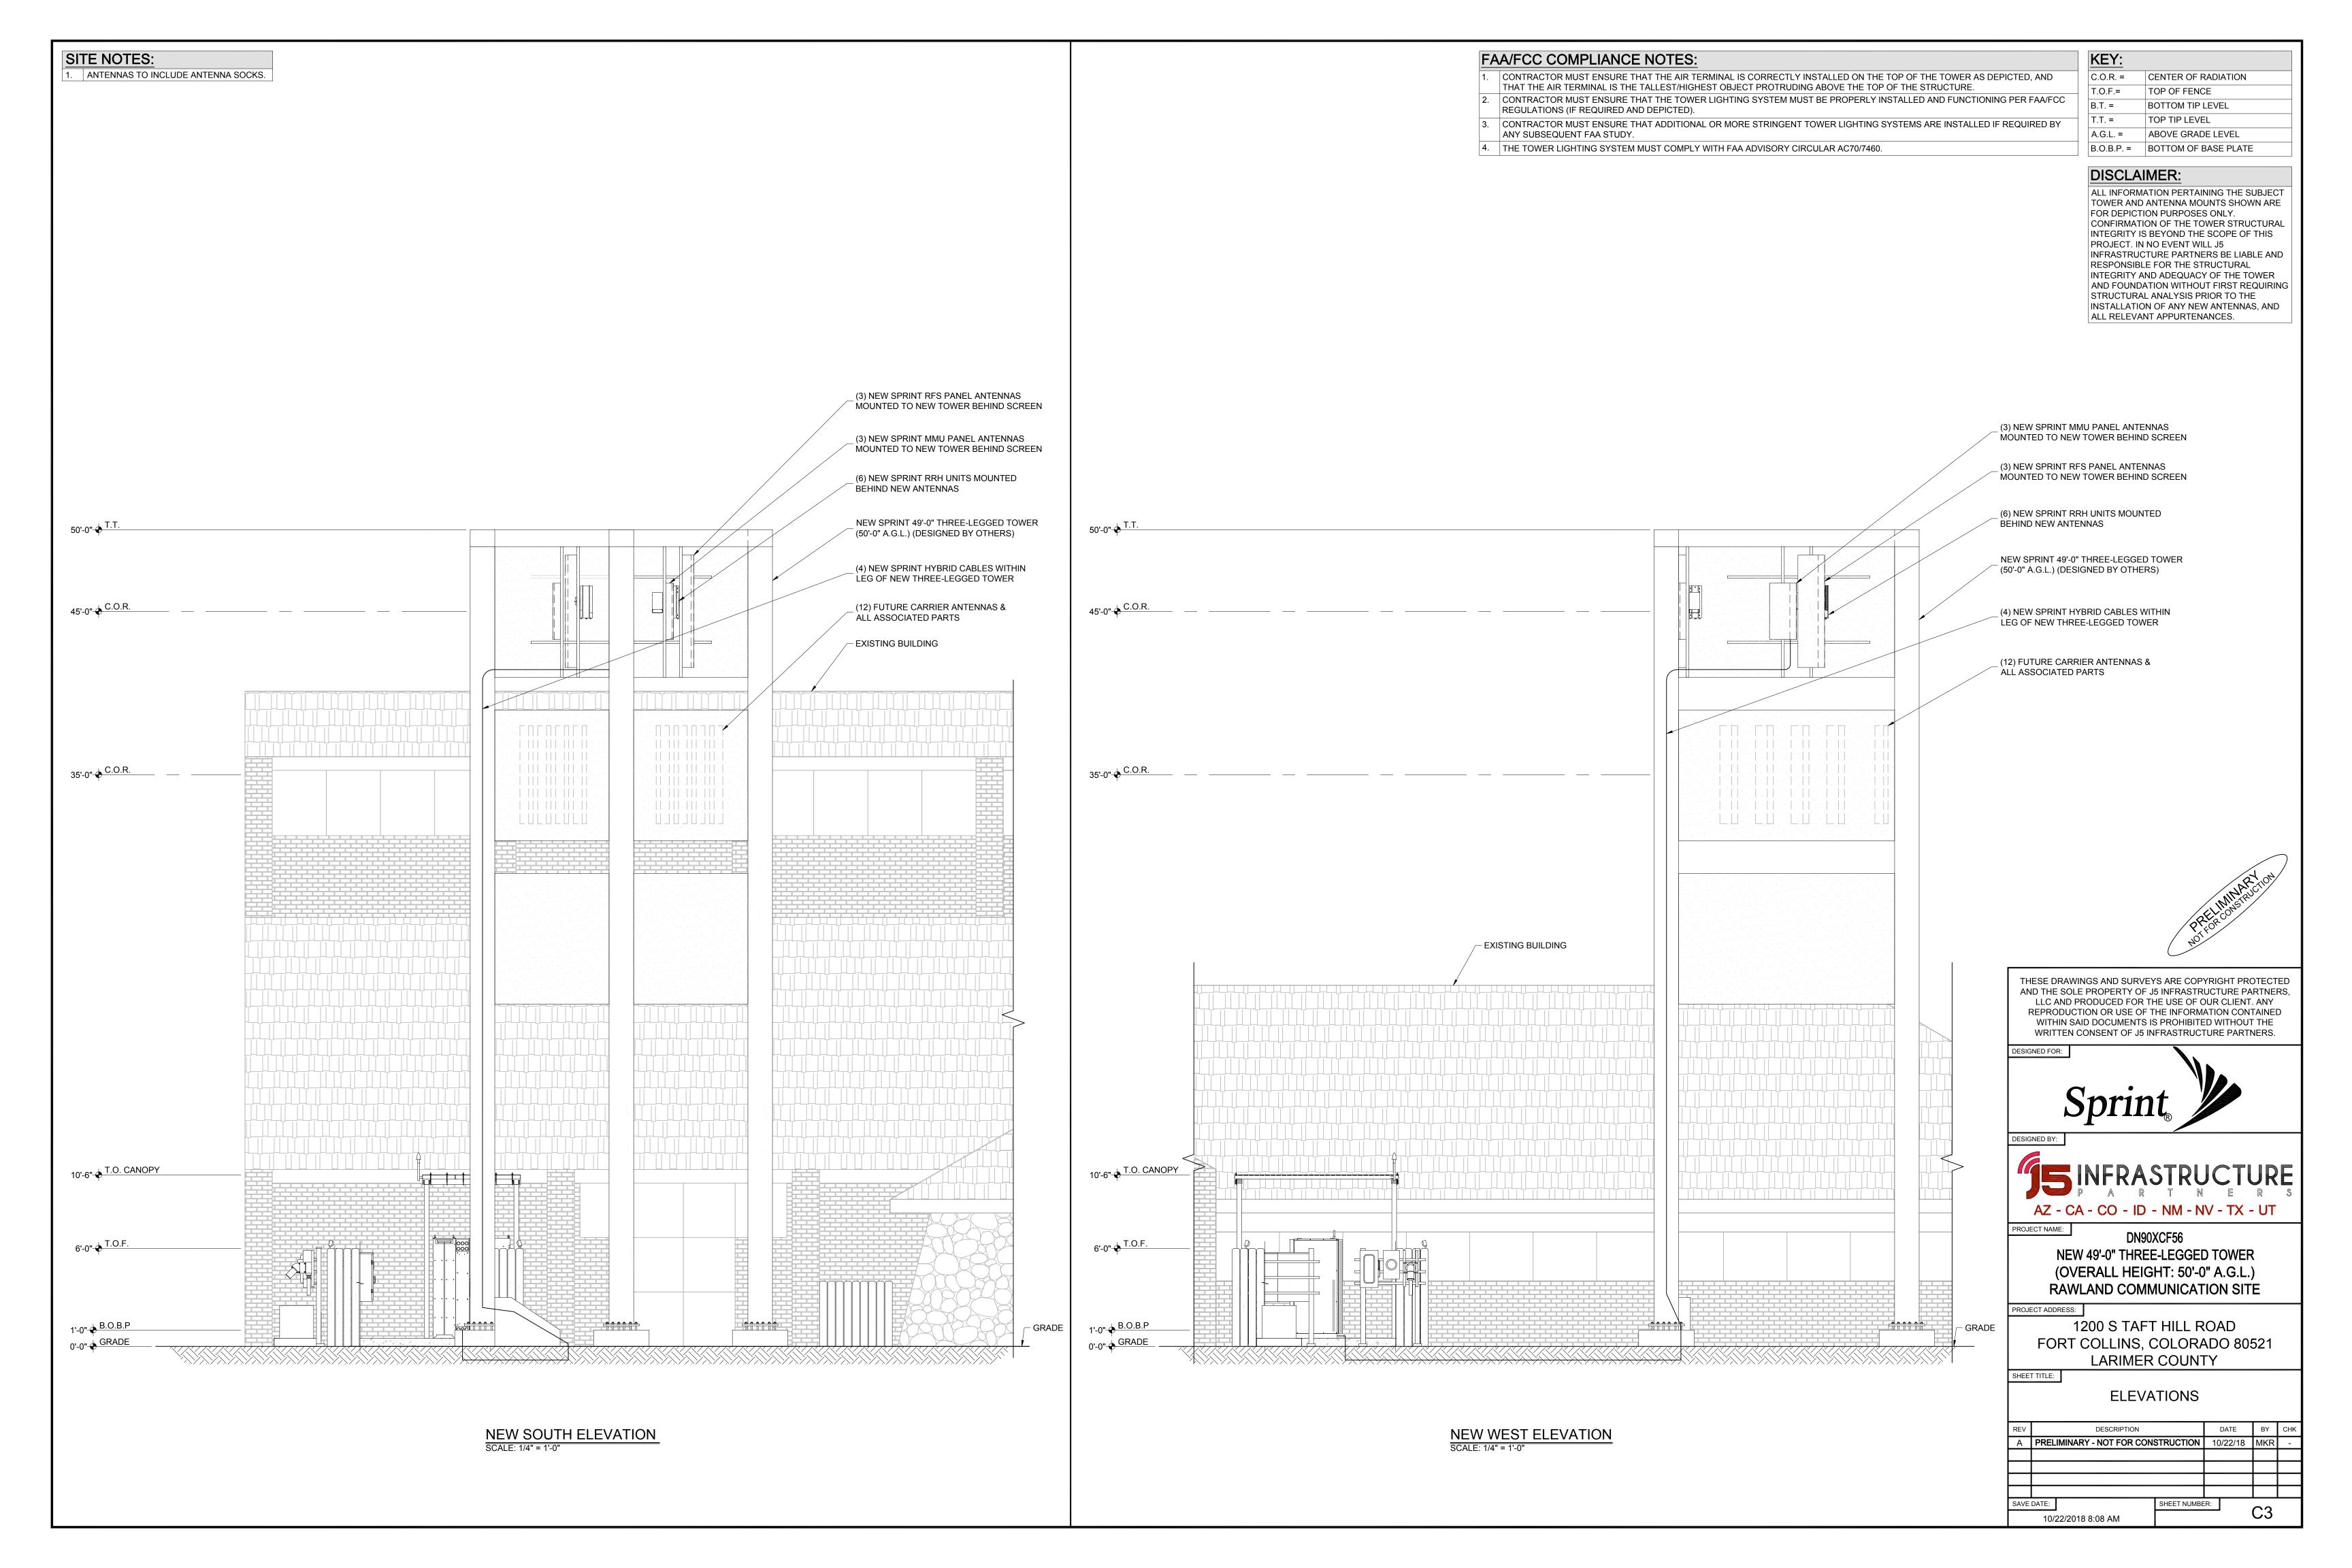











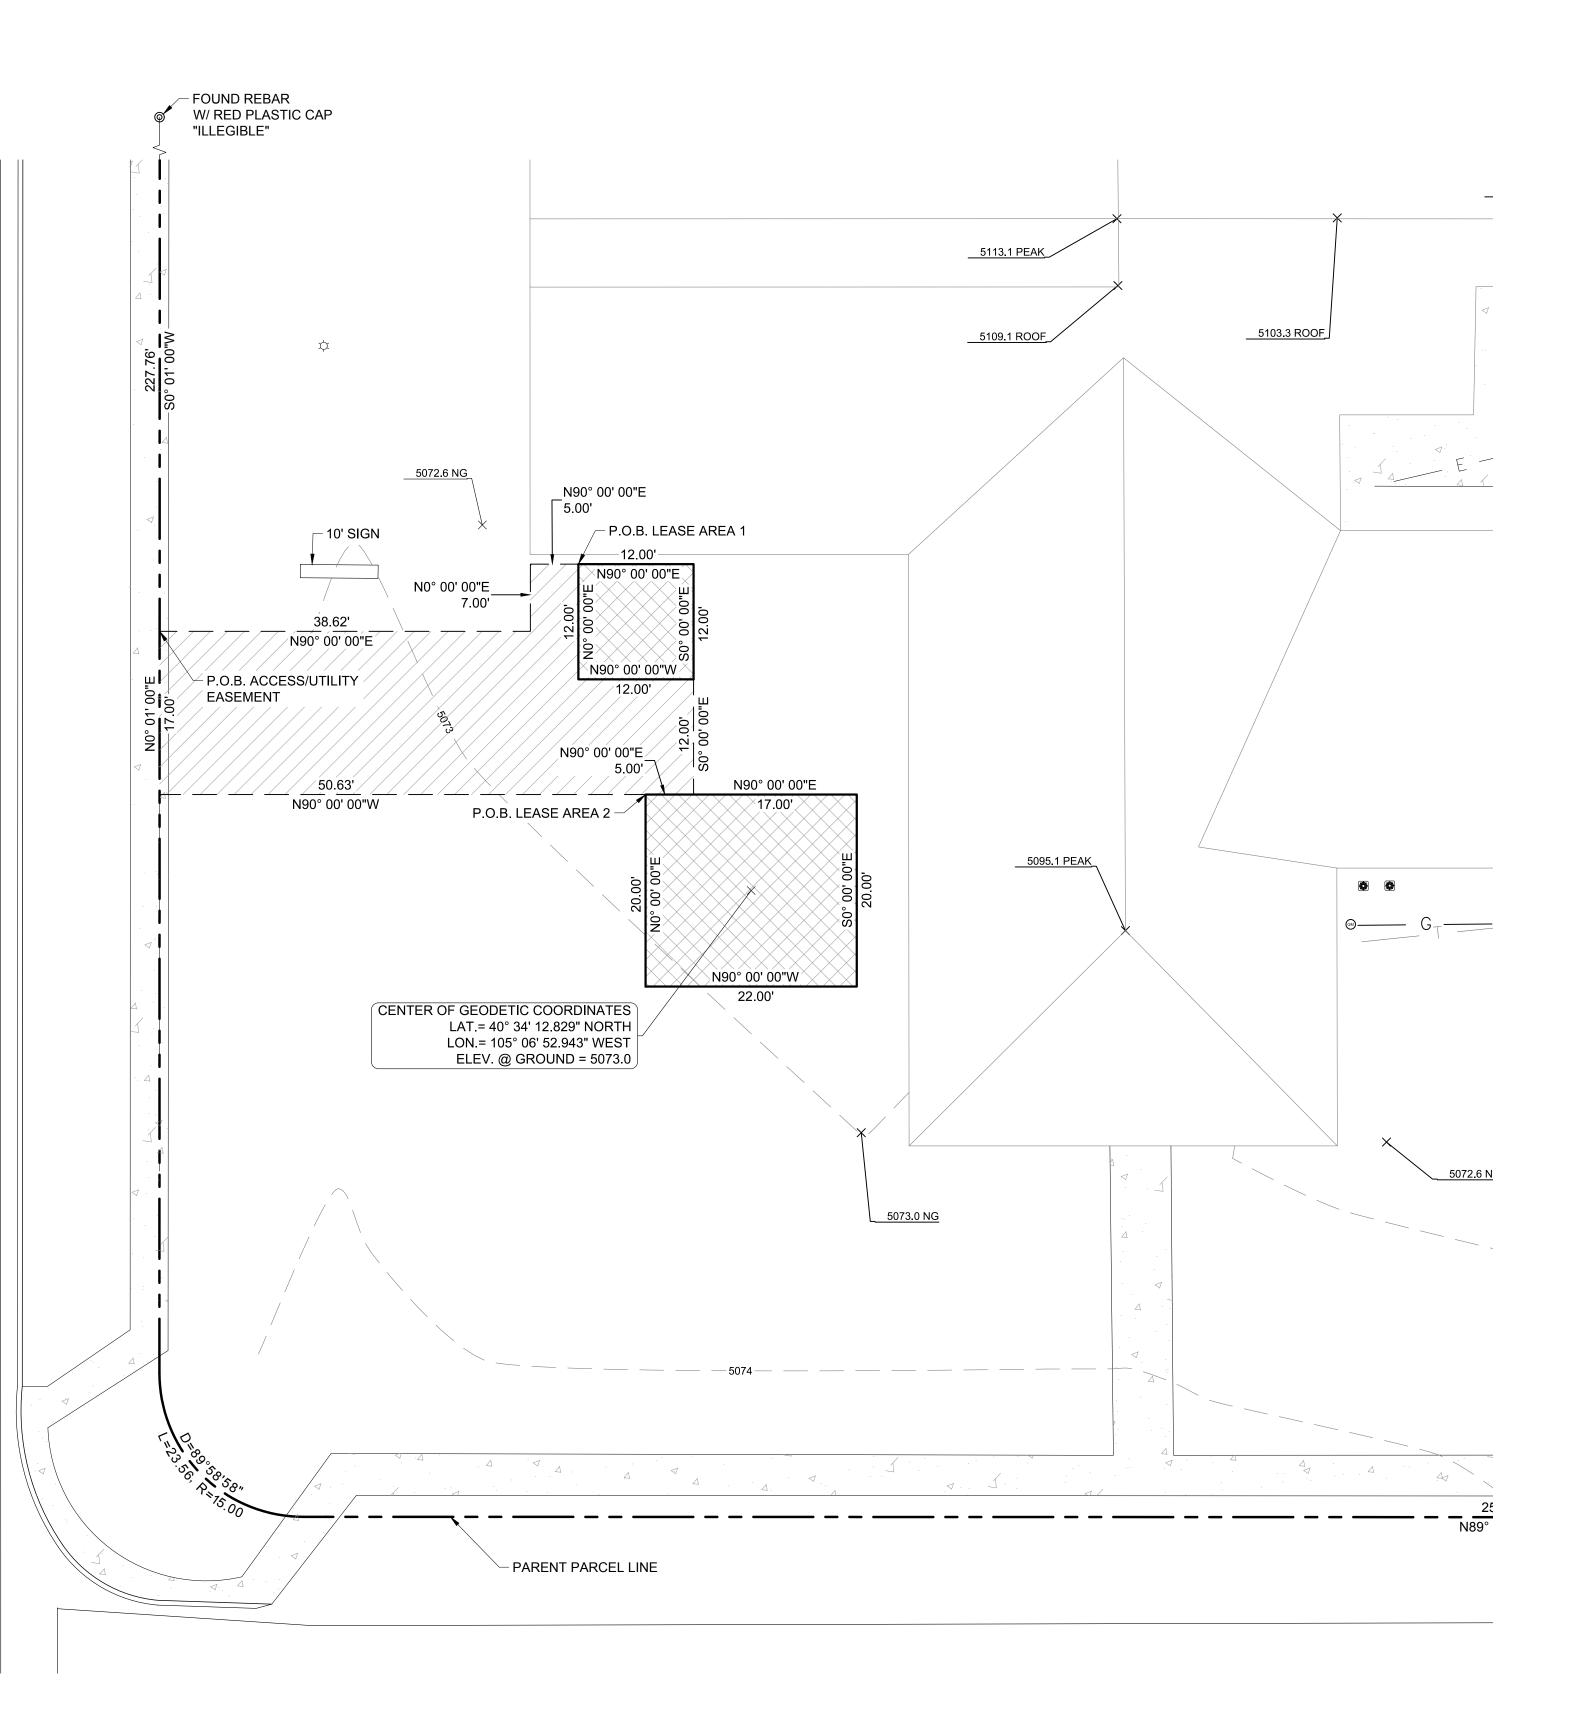

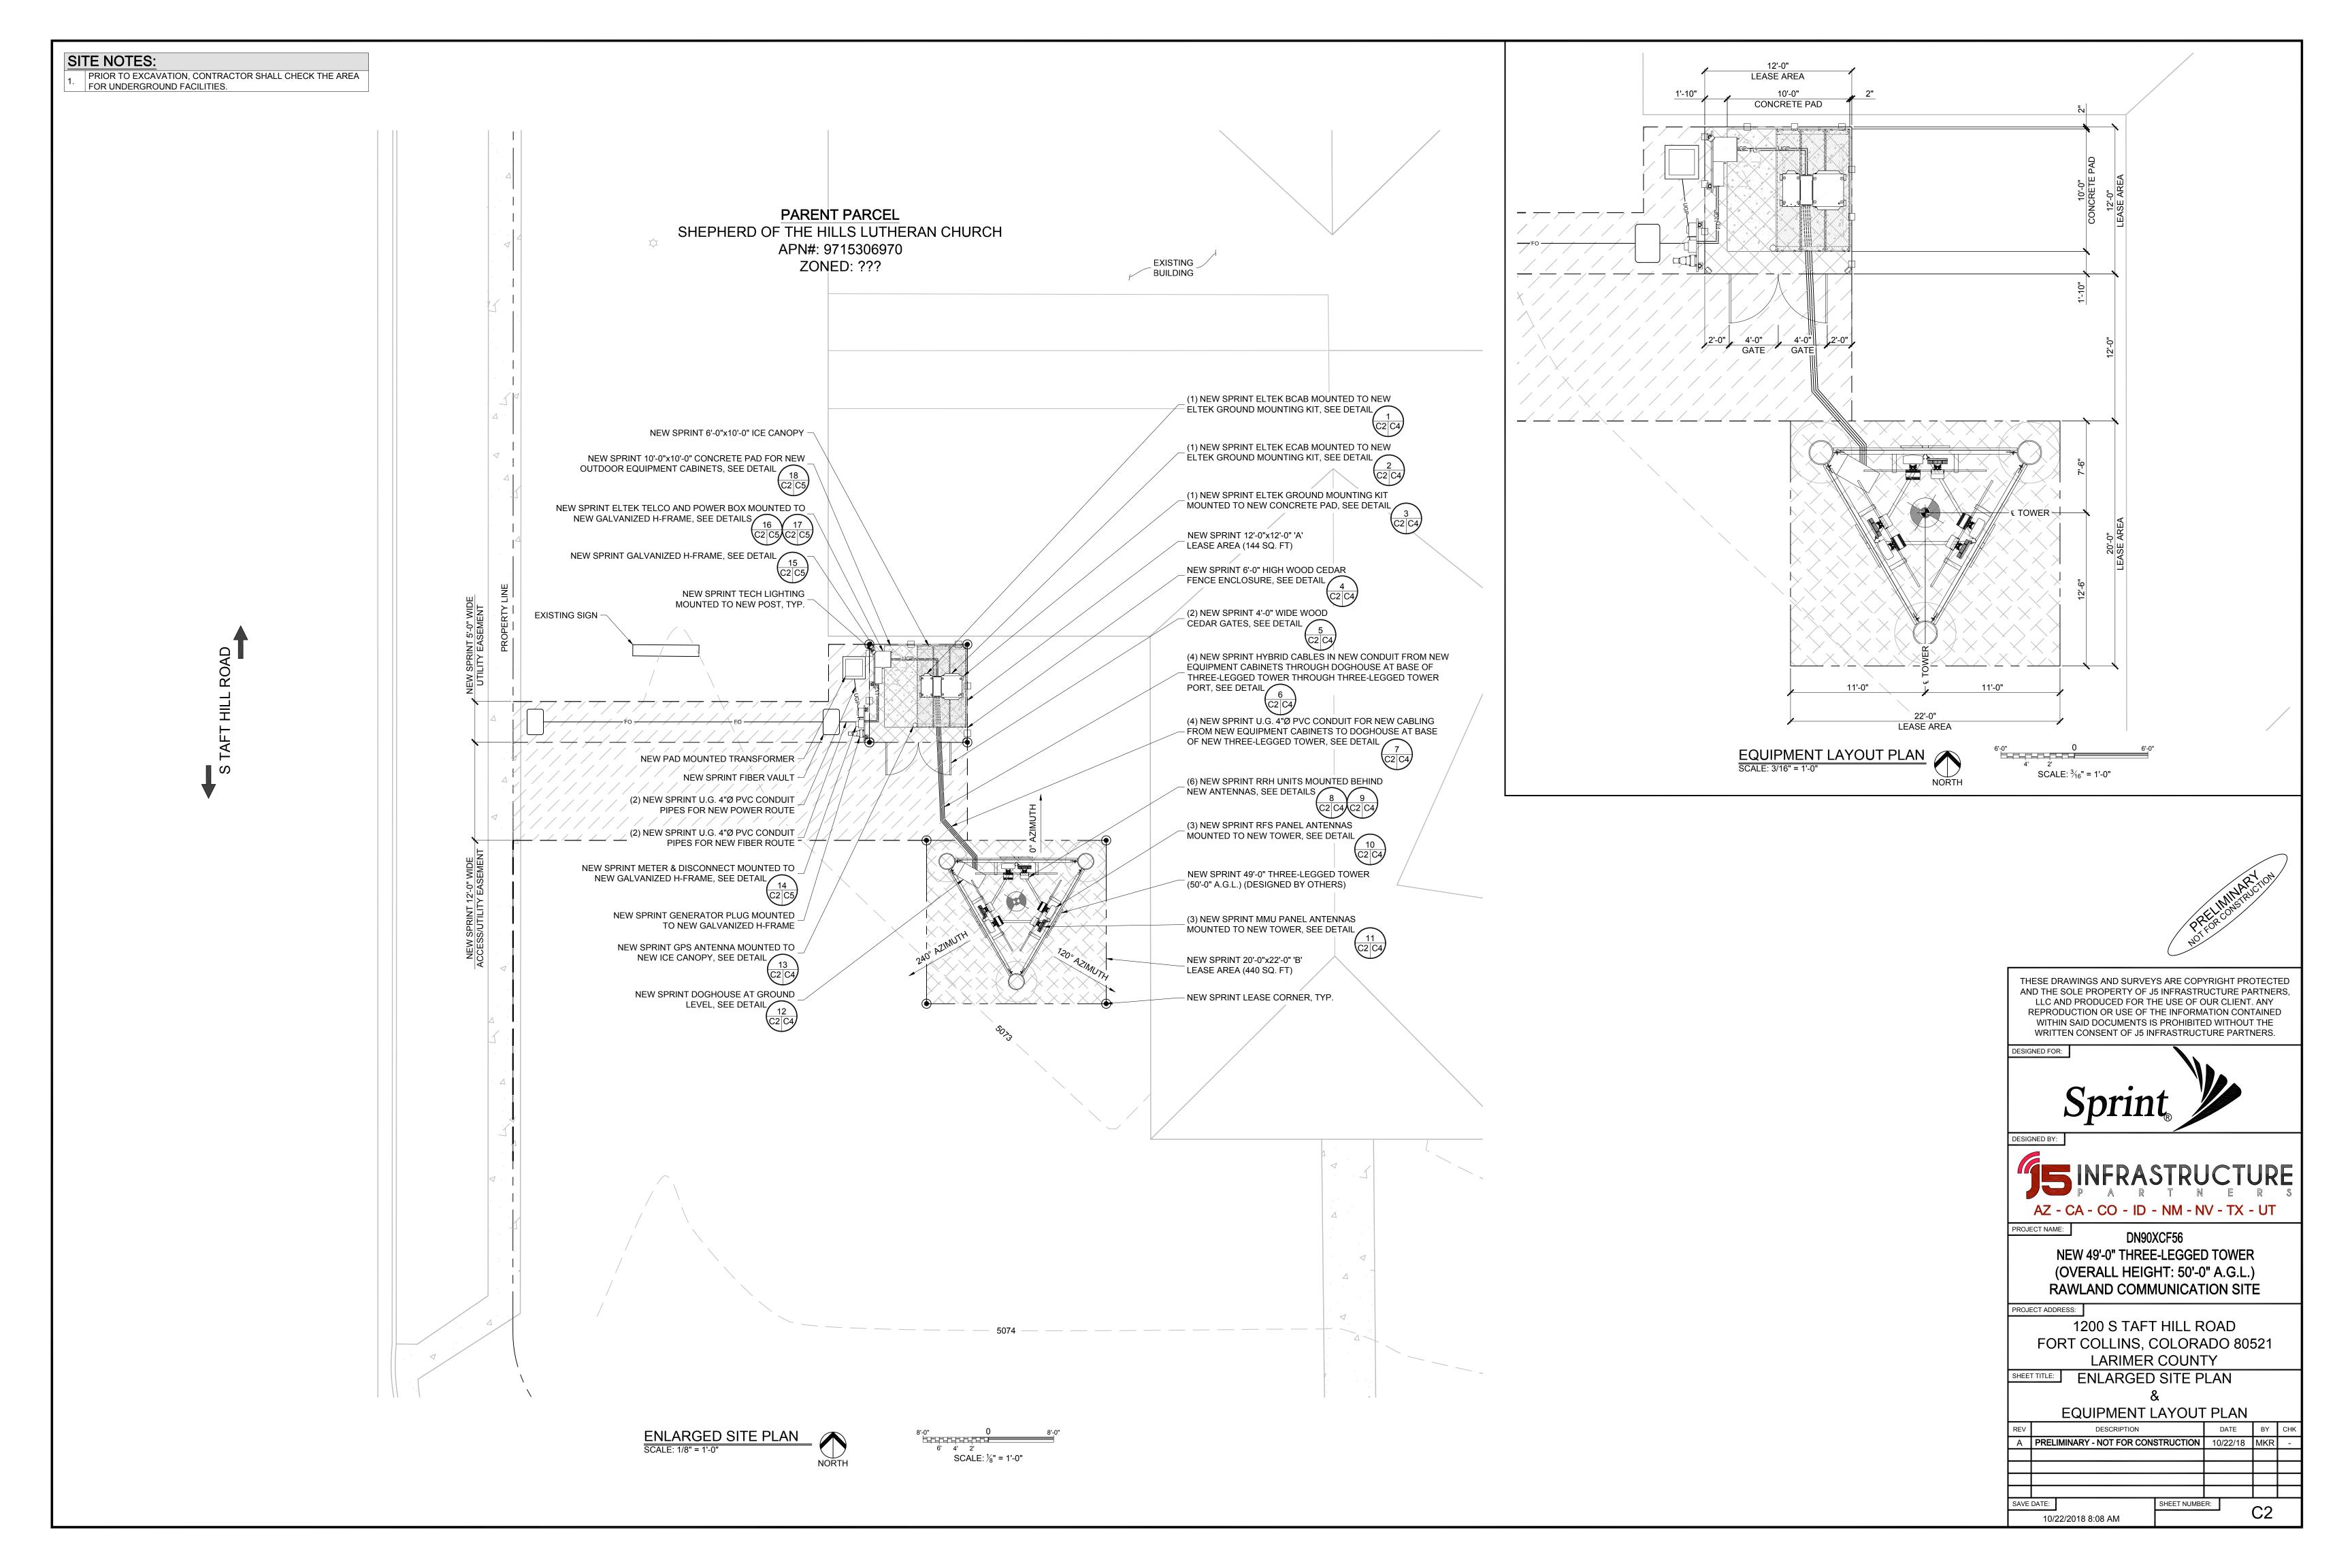

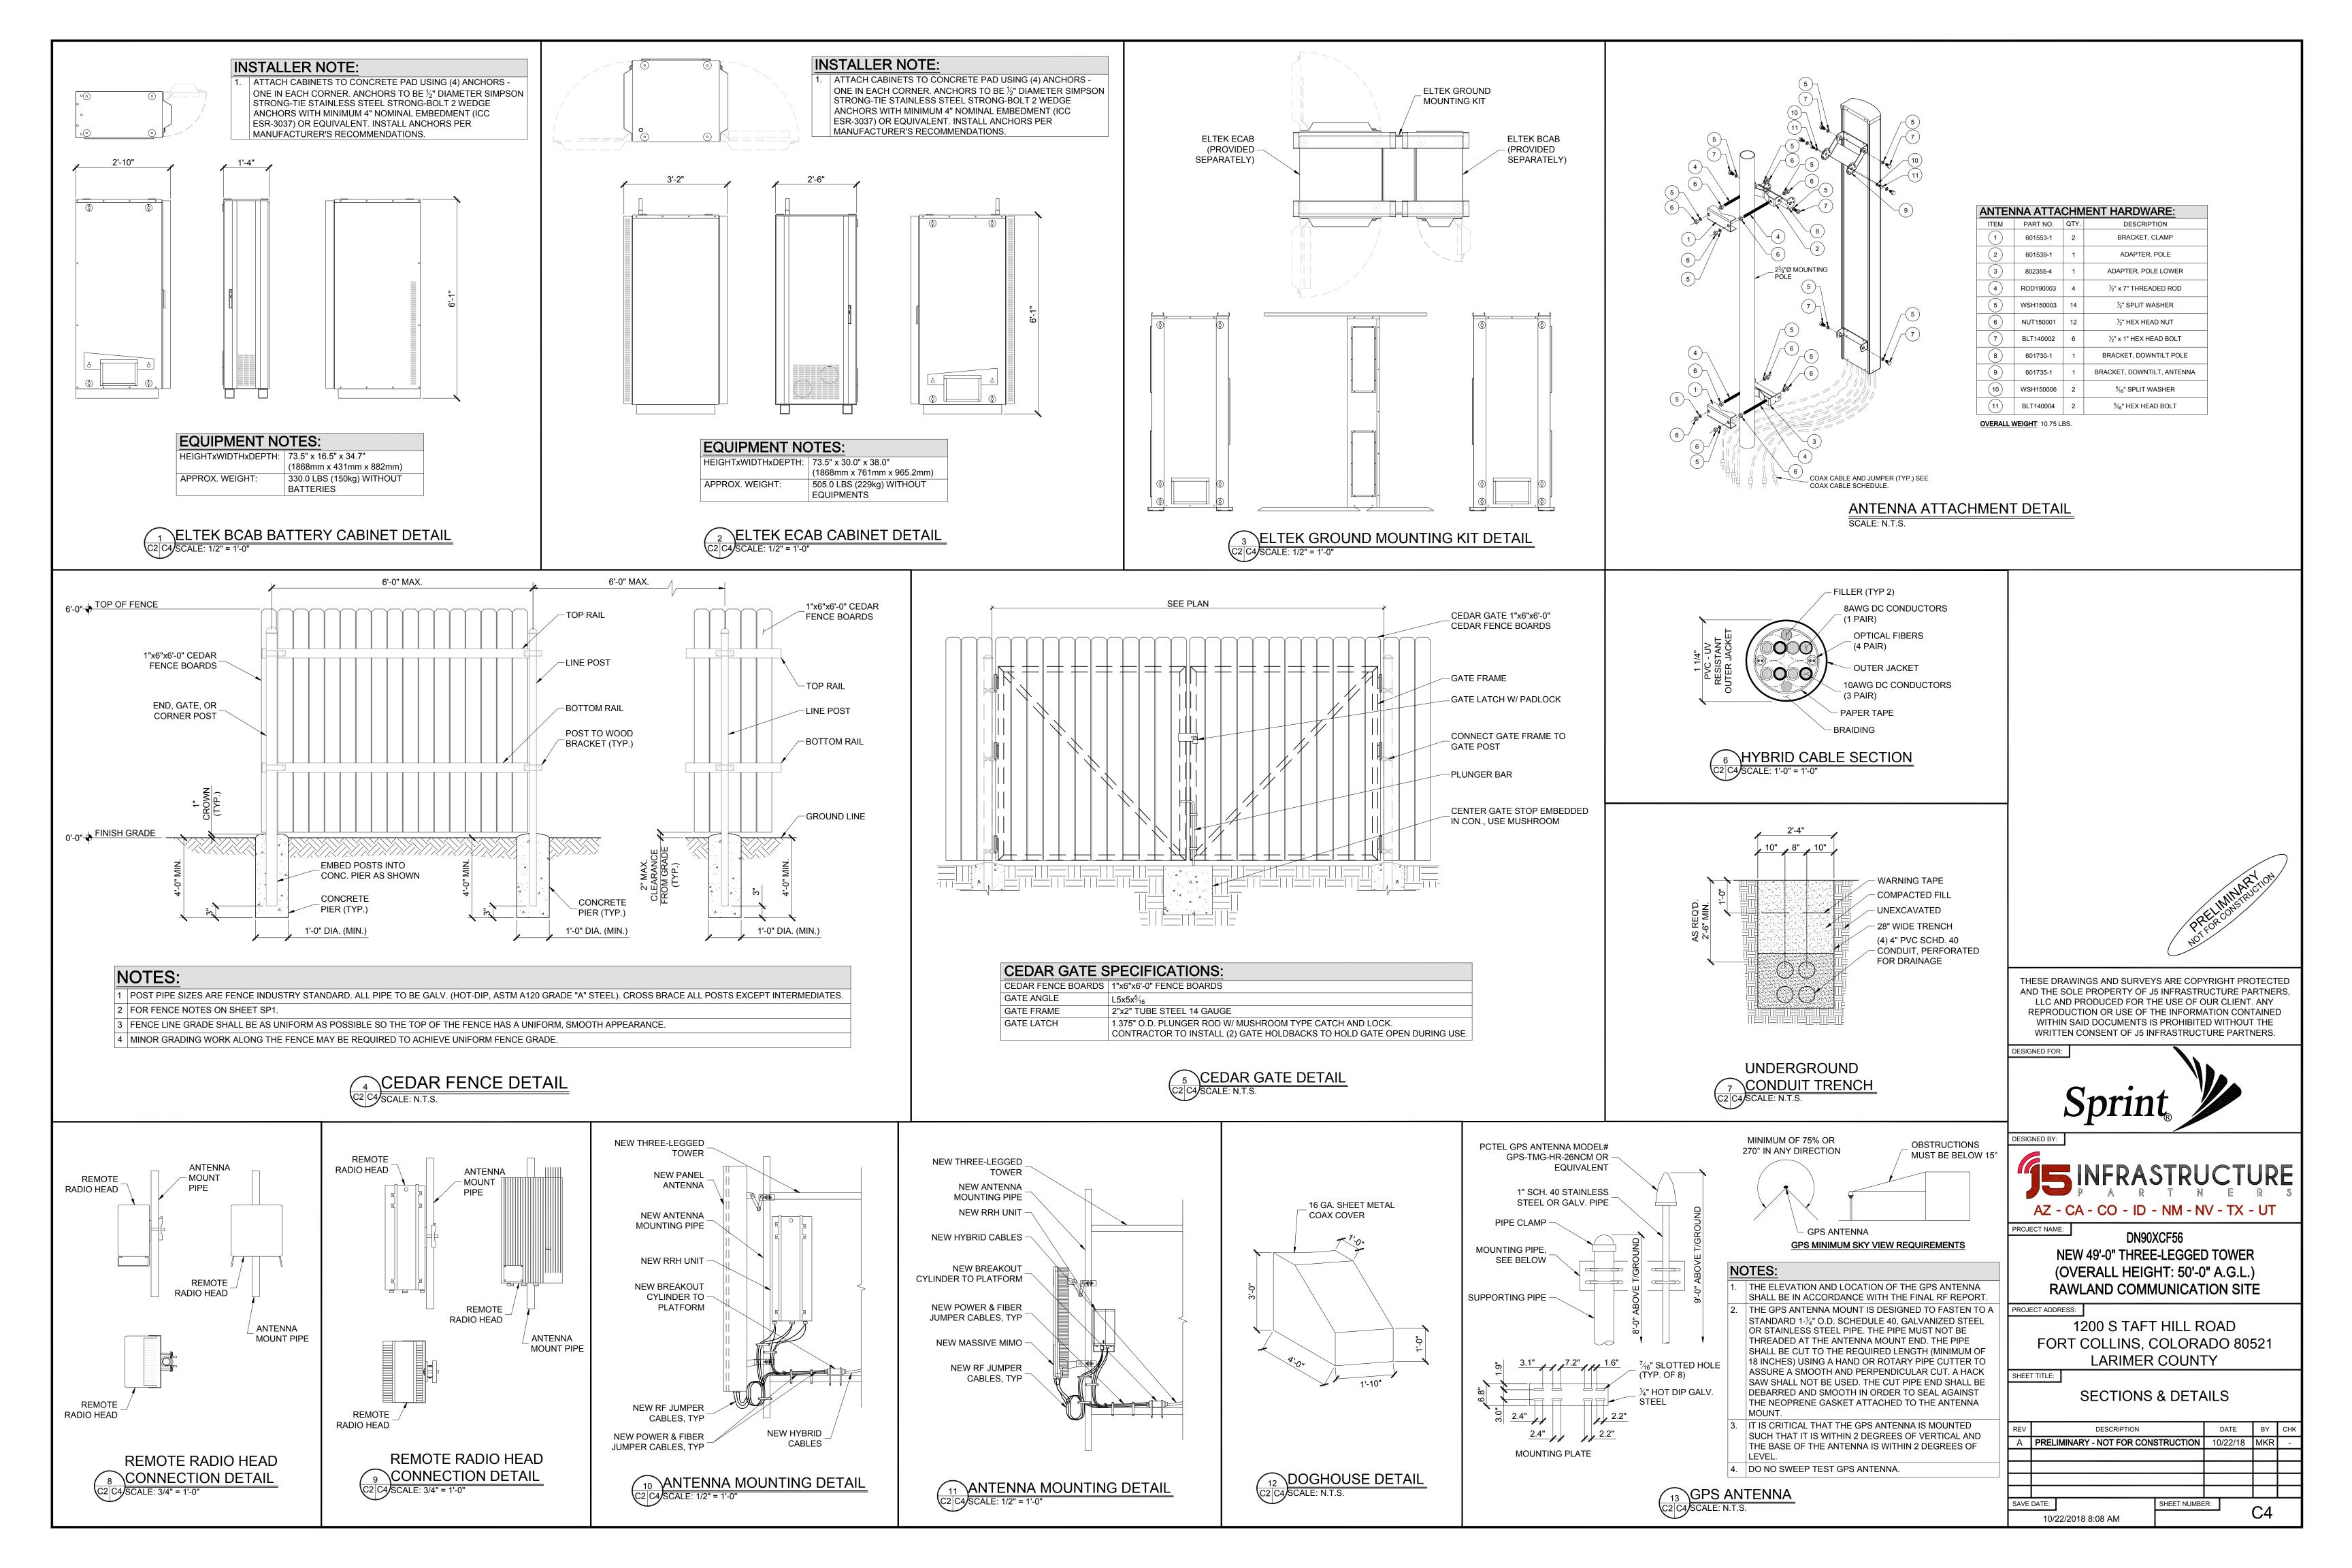

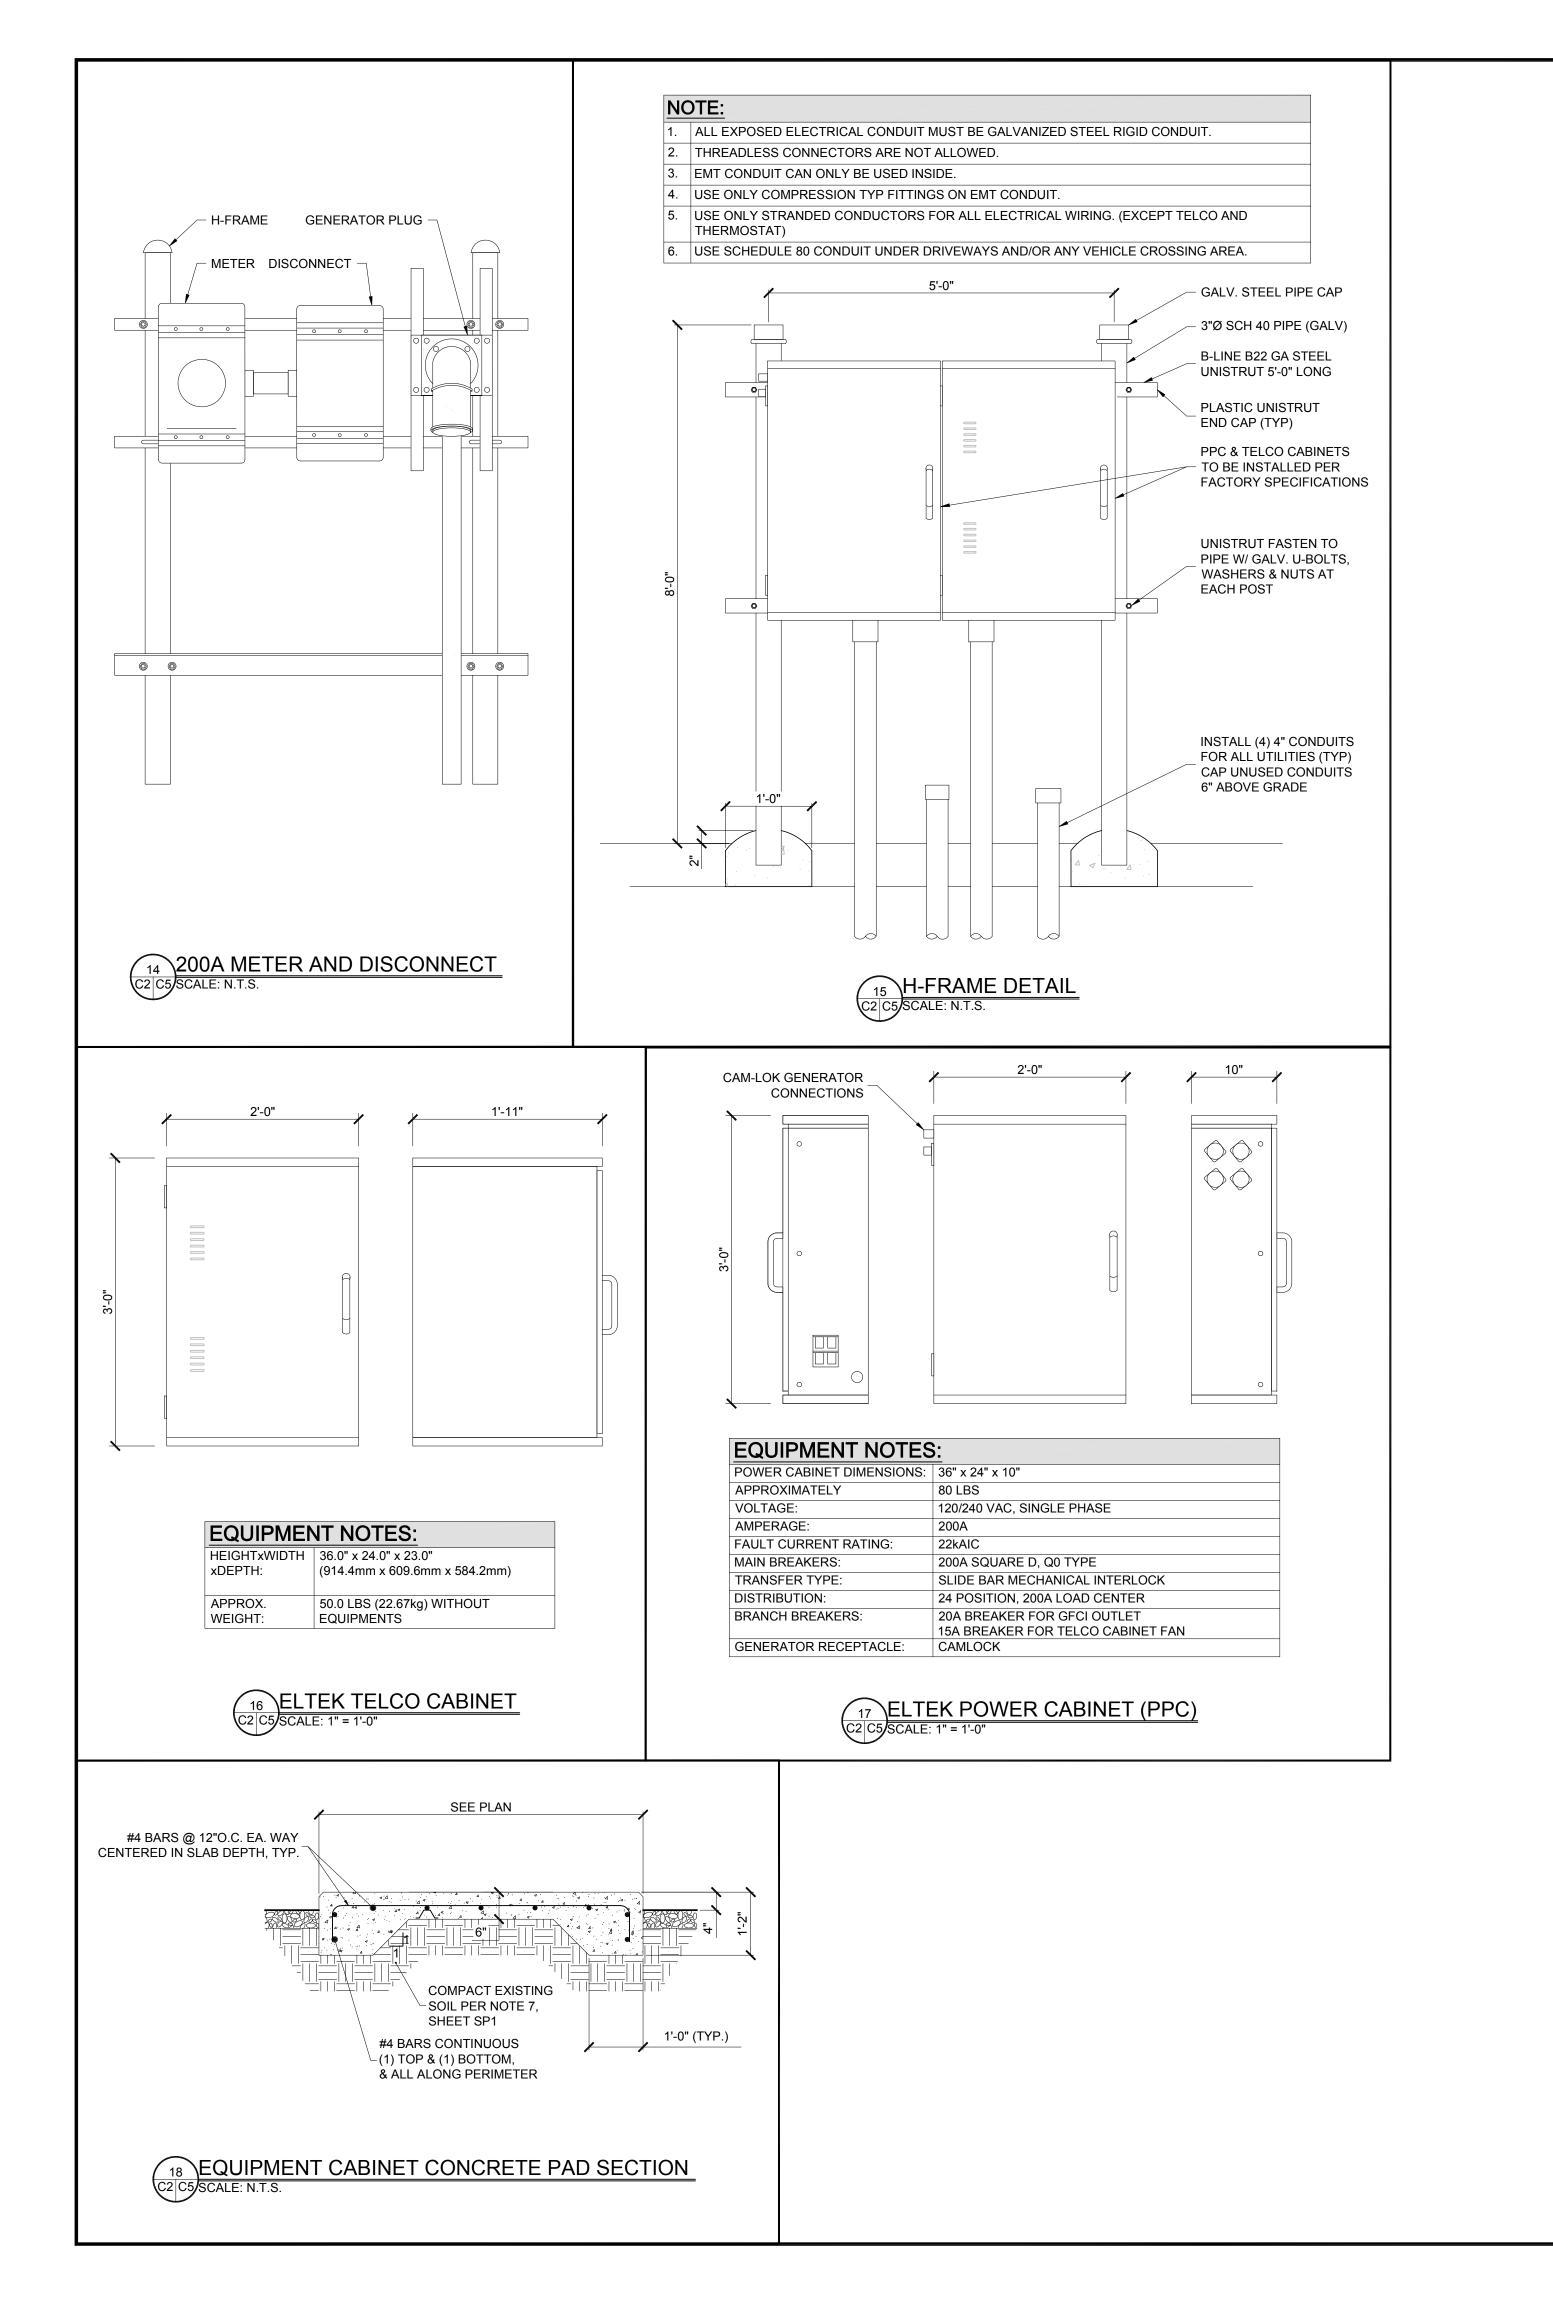

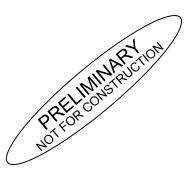

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DESIGNED FOR:



DESIGNED BY:



AZ - CA - CO - ID - NIVI - NV - IX -

PROJECT NAME:

DN90XCF56

NEW 49'-0" THREE-LEGGED TOWER

(OVERALL HEIGHT: 50'-0" A.G.L.)

RAWLAND COMMUNICATION SITE

PROJECT ADDRESS:

1200 S TAFT HILL ROAD FORT COLLINS, COLORADO 80521

LARIMER COUNTY

SHEET TITLE:

SECTIONS & DETAILS


| REV | DESCRIPTION | | | [| DATE | BY | CHK |
|-----------------------|------------------------------------|----|--|--------------|--------|-----|-----|
| Α | PRELIMINARY - NOT FOR CONSTRUCTION | | | 10 | /22/18 | MKR | - |
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| SAVE DATE: SHEET NUMB | | R: | | $\bigcirc E$ | | | |
| 10/22/2018 8:08 AM | | | | | | C5 | |

| NEW SPRINT ANTENNA SCHEDULE: | | | | | | | | |
|------------------------------|------------------------|---|---------------------|-------------------------|-----------------------------------|-----------------------------------|-------------------------|-----------------|
| ATTACH LEVEL (COR) | AZIMUTHS (DEG., MN) | ANTENNA TYPE | ANTENNA QUANTITY | MOUNT TYPE | COAX (QUANTITY) SIZE (NOMINAL) | ESTIMATED COAX CABLE LENGTH | MECHANICAL DOWN TILT | PIPE Ø (DxL) |
| 45'-0" | 0° 120° | RFS APXVBBLL20X_43-C-I20 7' PANEL ANTENNA SAMSUNG MMU | 3 | SEE ANTENNA MOUNT | (4) HYBRID CABLES (NEW) | SEE PLUMBING | - | 3.5"x96" |
| NOTES: | 240° | 3' PANEL ANTENNA | 3 | SCHEDULE | | DIAGRAM | | |

1. FOR EXACT ANTENNA INFORMATION REFER TO THE RF DESIGN.

2. ALL NEW COAX SHALL BE INSTALLED ON INSIDE OF NEW/EXISTING THREE-LEGGED TOWER (IF POSSIBLE).

3. CONTRACTOR TO INSTALL DIPLEXERS IN SHELTER AND ON TOWER AS REQUIRED BY RF DESIGN (IF APPLICABLE).

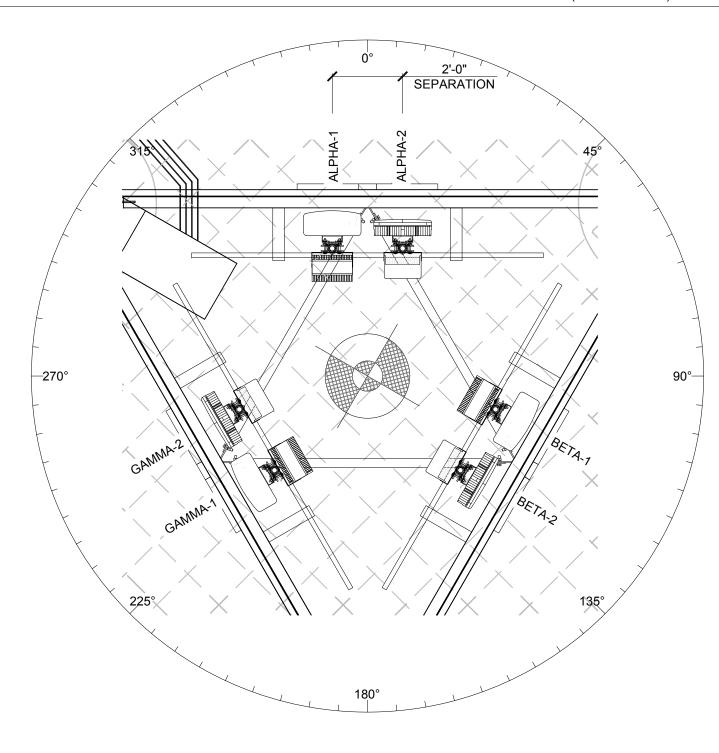


ANTENNA SECTION @ 45'-0"
SCALE: N.T.S.
NORTH

GENERAL ANTENNA NOTES:

- 1. DUAL POLAR ANTENNAS REQUIRE TWO RUNS OF COAX PER ANTENNA.
- 2. LENGTHS GIVEN ON THIS CHART ARE ESTIMATED FROM AVAILABLE INFORMATION.
- 3. TYPES AND SIZES OF THE ANTENNA CABLES ARE BASED ON THE ESTIMATED LENGTH OF THE CABLES. CONTRACTOR TO VERIFY ALL ACTUAL LENGTHS IN FIELD PRIOR TO INSTALLATION AND NOTIFY THE FIELD ENGINEER FOR VERIFICATION OF SIZES OF CABLES.
- 4. CONTRACTOR TO PROVIDE AS BUILT FOR THE LENGTH OF CABLES UPON COMPLETION OF INSTALLATION.
- 5. CONTRACTOR TO PROVIDE FINAL CABLE LENGTHS AND RETURN LOSSES FOR ALL
- 6. ALL AZIMUTHS REFERENCE TRUE NORTH. CONSULT REQUIRED QUADRANGLE MAP FOR NECESSARY MECHANICAL DECLINATION.

NOTICE:

1. CONTRACTOR SHALL NOT SUBMIT BIDS OR PERFORM CONSTRUCTION WORK ON THIS PROJECT WITHOUT ACCESS TO THE CURRENT COMPLETE SET OF DRAWINGS LISTED IN THE TITLE-SHEET INDEX.

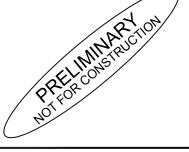

| <u>NEV</u> | <u>V HYBRID C</u> | CABLE LENGTHS: | | |
|-------------|-------------------|------------------------------|--------------------------|-----------------------------------|
| FROM | I (MAIN OVP) TO | (MAIN OVP) | | |
| MAIN | SECTOR | CABLE/COAX CABLE/ | | ESTIMATED CABLE/COAX LENGTH |
| _ ⊢ | - | HYB 5X24 | 4 | ~75' |
| FROM | I (MAIN OVP) TO | (RRH) | | |
| RS | SECTOR | CABLE/COAX SIZE (NOMINAL) | CABLE/COAX (QUANTITY) | ESTIMATED CABLE/COAX LENGTH |
| | | HYB 1X1 | 1 | ~5' |
| | ALPHA | HYB 1X1 | 1 | ~5' |
| 1PE | | HYB 1X1 | 1 | ~5' |
| RRH JUMPERS | | HYB 1X1 | 1 | ~5' |
| Ŧ, | BETA | HYB 1X1 | 1 | ~5' |
| 丞 | | HYB 1X1 | 1 | ~5' |
| | | HYB 1X1 | 1 | ~5' |
| | GAMMA | HYB 1X1 | 1 | ~5' |
| | | HYB 1X1 | 1 | ~5' |
| FROM | I (RRH) TO (ANTE | ENNAS) | | |
| | | CABLE/COAX | CABLE/COAX | ESTIMATED |

RRH HYBRID CABLE CHART SCALE: N.T.S.

CABLE/COAX

(QUANTITY)

CABLE/COAX

LENGTH

CUT TO FIT

CUT TO FIT

CUT TO FIT

CABLE/COAX

SIZE (NOMINAL)

½"Ø

½"Ø

SECTOR

ALPHA

BETA

GAMMA

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PROJECT NAME:

DN90XCF56 NEW 49'-0" THREE-LEGGED TOWER (OVERALL HEIGHT: 50'-0" A.G.L.) RAWLAND COMMUNICATION SITE


PROJECT ADDRESS:

1200 S TAFT HILL ROAD FORT COLLINS, COLORADO 80521 LARIMER COUNTY

SHEET TITLE:

ANTENNA INFORMATION & RRH HYBRID CABLE CHART

| THE ONE OF THE | | | | | | | |
|----------------|-------|------------------------------------|-------------|---|-------|-----|--|
| REV | | DESCRIPTION | | | BY | CHK | |
| Α | PREL | PRELIMINARY - NOT FOR CONSTRUCTION | | | MKR | - | |
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| SAVE | DATE: | | SHEET NUMBE | | 7 - 4 | | |
| | 10/ | 22/2018 8:08 AM | | F | RF1 | | |

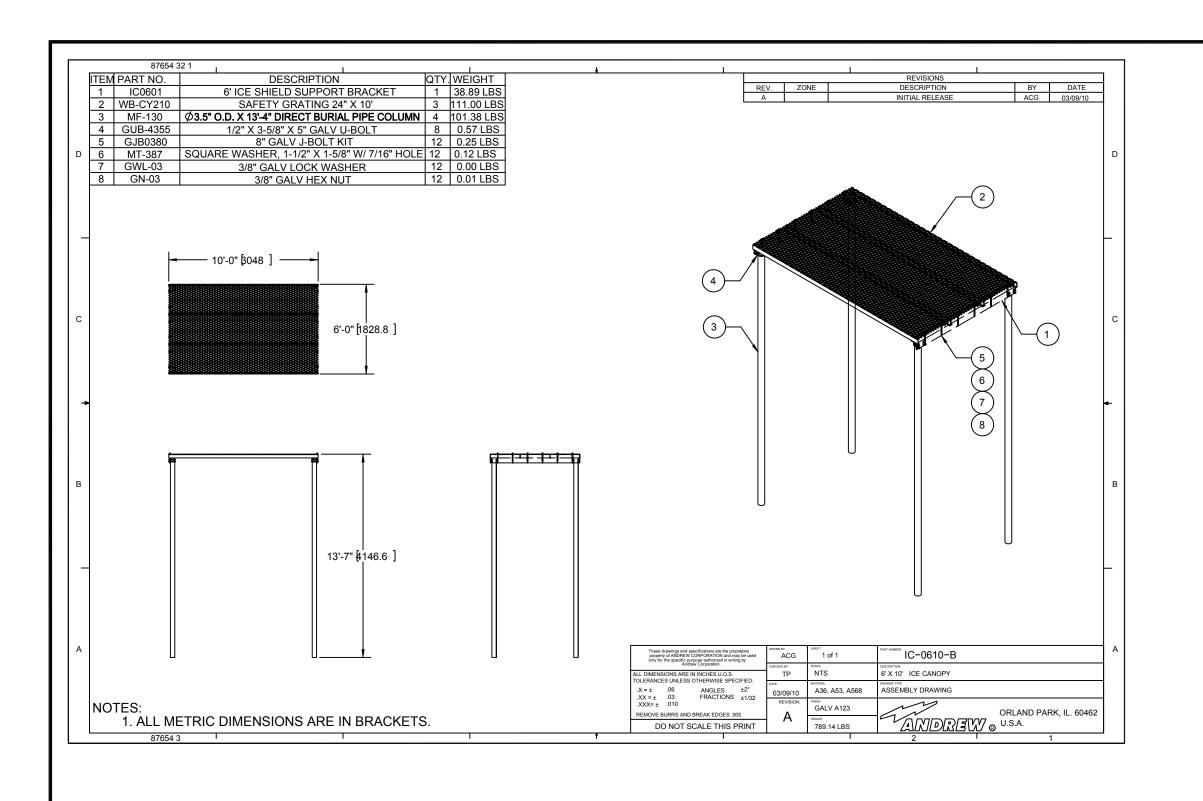

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ESIGNED FOR:



DESIGNED BY:



PROJECT NAME:

DN90XCF56

NEW 49'-0" THREE-LEGGED TOWER

(OVERALL HEIGHT: 50'-0" A.G.L.)

RAWLAND COMMUNICATION SITE


PROJECT ADDRESS:

1200 S TAFT HILL ROAD FORT COLLINS, COLORADO 80521 LARIMER COUNTY

SHEET TITLE:

ICE CANOPY DETAIL

| REV | DESCRIPTION | | | D | ATE | BY | CHK |
|--------------------|------------------------------------|--|-------------|-----|----------|-----|-----|
| Α | PRELIMINARY - NOT FOR CONSTRUCTION | | | 10/ | 22/18 | MKR | - |
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| SAVE | DATE: | | SHEET NUMBE | R: | | שר | |
| 10/22/2018 8:08 AM | | | | | | RF2 | |

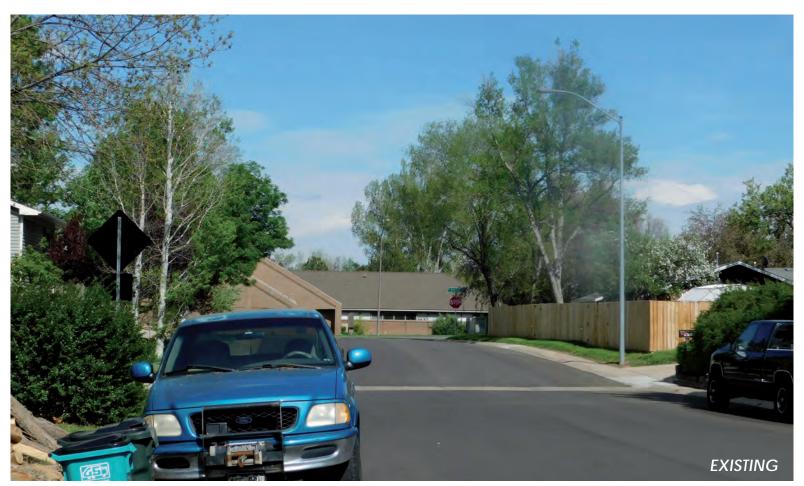



PHOTOSIMULATION INSTALL (6) PANEL ANTENNAS, (6) RRU'S INSIDE PROPOSED 50' THREE LEGGED TOWER







PHOTOSIMULATION INSTALL (6) PANEL ANTENNAS, (6) RRU'S INSIDE PROPOSED 50' THREE LEGGED TOWER







PHOTOSIMULATION INSTALL (6) PANEL ANTENNAS, (6) RRU'S INSIDE PROPOSED 50' THREE LEGGED TOWER










Sunshine House Early Learning Center

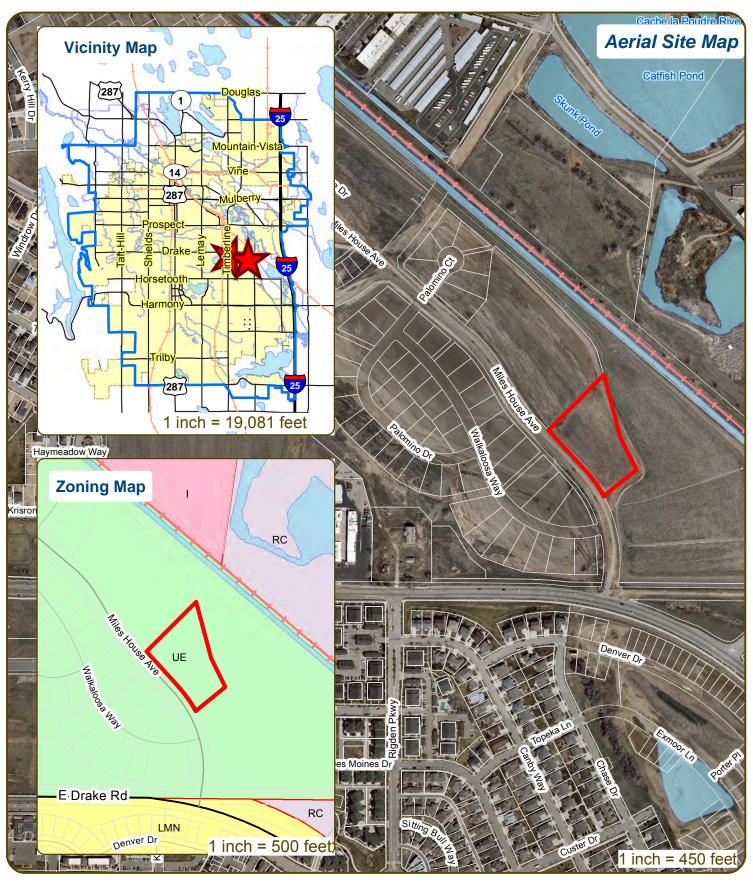

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CONCEPTUAL REVIEW: **APPLICATION**

General Information

All proposed land development projects begin with Conceptual Review. Anyone with a land development idea can schedule a Conceptual Review meeting to get feedback on prospective development ideas. At this stage, the development idea does not need to be finalized or professionally presented. However, a sketch plan or site plan and this application must be submitted to City Staff prior to the Conceptual Review meeting. The more information you are able to provide, the better feedback you are likely to get from the meeting. Generally, Conceptual Review works best after a brief conversation with a representative from the Zoning or Planning Department to first establish compliance with the permitted uses under the applicable zone district. Then a sketch plan or site plan is prepared that allows staff to review and provide comments on the land development aspects of the proposal. Please be aware that any information submitted may be considered a public record, and may be made available to anyone who requests it, including the media. The applicant acknowledges that that they are acting with the owner's consent.


Conceptual Reviews are scheduled on three Thursday mornings per month on a "first come, first served" basis. One 45 meeting is allocated per applicant and only three conceptual reviews are held each Thursday morning. Conceptual Review is a free service. Complete applications and sketch plans must be submitted to City Staff no later than 12:00pm. two Tuesdays prior to the meeting date. Application materials must be e-mailed to currentplanning@fcgov.com. If you do not have access to e-mail, other accommodations can be made upon request.

At Conceptual Review, you will meet with Staff from various City departments, including Community Development and Neighborhood Services (Zoning, Planning, and Development Review Engineering), Light and Power, Stormwater, Water/ Waste Water, Transportation Planning and Poudre Fire Authority. Staff provides the applicant with comments to assist in preparing the detailed formal project application. There is no approval or denial of development proposals associated with Conceptual Review. The applicant will receive the comment letter at the review meeting.

| *BOLDED ITEMS ARE REQUIRED* Contact Name(s) and Role(s) (Please | | |
|--|--|--|
| Business Name (if applicable)Your Mailing Address | | |
| Phone Number | Email Address | |
| Site Address or Description (parcel | # if no address) | |
| Description of Proposal (attach addi | itional sheets if necessary) | |
| | | |
| Proposed Use | Existing Use | |
| Total Building Square Footage | | |
| Age of any Existing Structures Info available on Larimer County's Websit If any structures are 50+ years old, good of | e: http://www.co.larimer.co.us/assesso | r/query/search.cfm structure are required for conceptual. |
| Is your property in a Flood Plain? Info available on FC Maps: http://gisweb.fc | ☐ Yes ☐ No ☐ If yes, then what cgov.com/redirect/default.aspx?layerTr | risk level? neme=Floodplains. |
| Increase in Impervious Area(Approximate amount of additional building | g, pavement, or etc. that will cover exis | S.F. sting bare ground to be added to the site) |
| Suggested items for the Sketch Plan: | | |

Property location and boundaries, surrounding land uses, proposed use(s), existing and proposed improvements (buildings, landscaping, parking/drive areas, water treatment/detention, drainage), existing natural features (water bodies, wetlands, large trees, wildlife, canals, irrigation ditches), utility line locations (if known), photographs (helpful but not required). Things to consider when making a proposal: How does the site drain now? Will it change? If so, what will change?



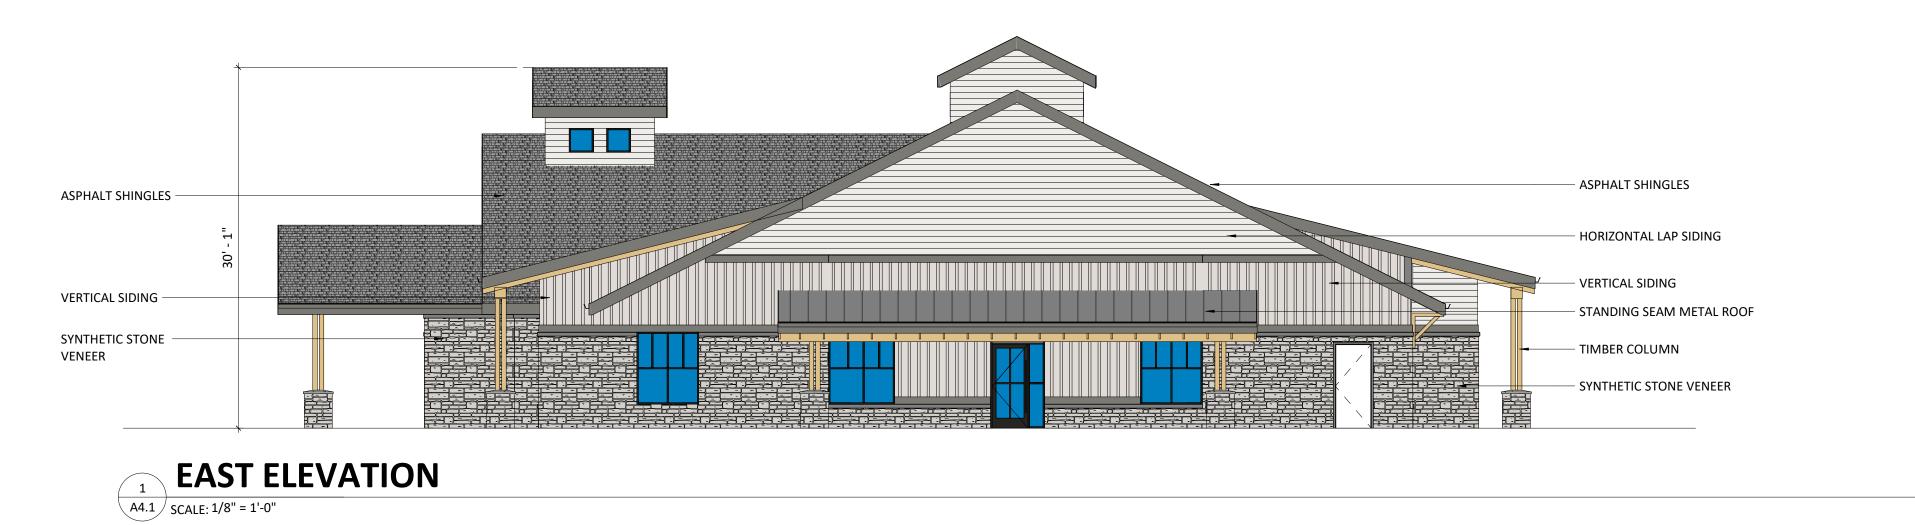





712 WHALERS WAY SUITE, B-100 FORT COLLINS, CO 80525 (970) 223-1820 www.alm2s.com

SUNSHINE HOUSE
AT BUCKING HORSE
Fort Collins, CO.


NO ISSUE DATE
PROJECT 1849
DATE 11/20/2018
DRAWN KJB
BUILDING ELEVATIONS

A4.1



SW PERSPECTIVE

A4.2 SCALE

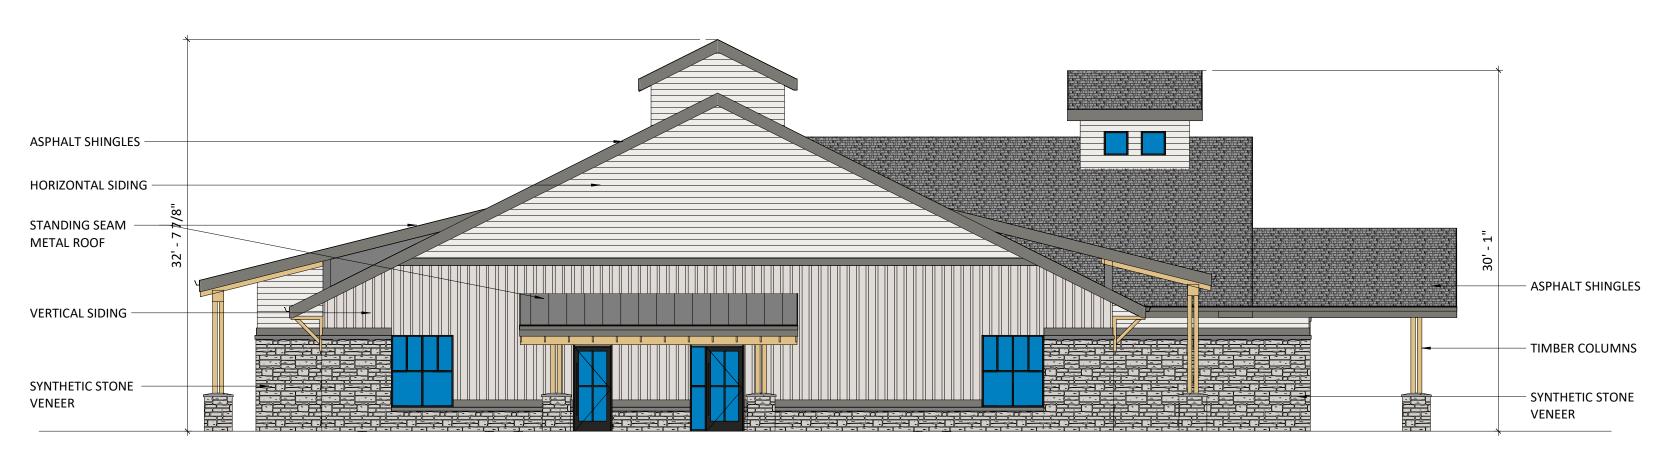

WEST ELEVATION

2 **VVESTE**A4.2 SCALE: 1/8" = 1'-0"



SOUTH ELEVATION

1 SCALE: 1/8" = 1'-0"




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SUNSHINE HOUSE
AT BUCKING HORSE
Fort Collins, CO.

NO ISSUE DATE
PROJECT 1849
DATE 11/20/2018
DRAWN KJB
BUILDING ELEVATIONS

A4.2

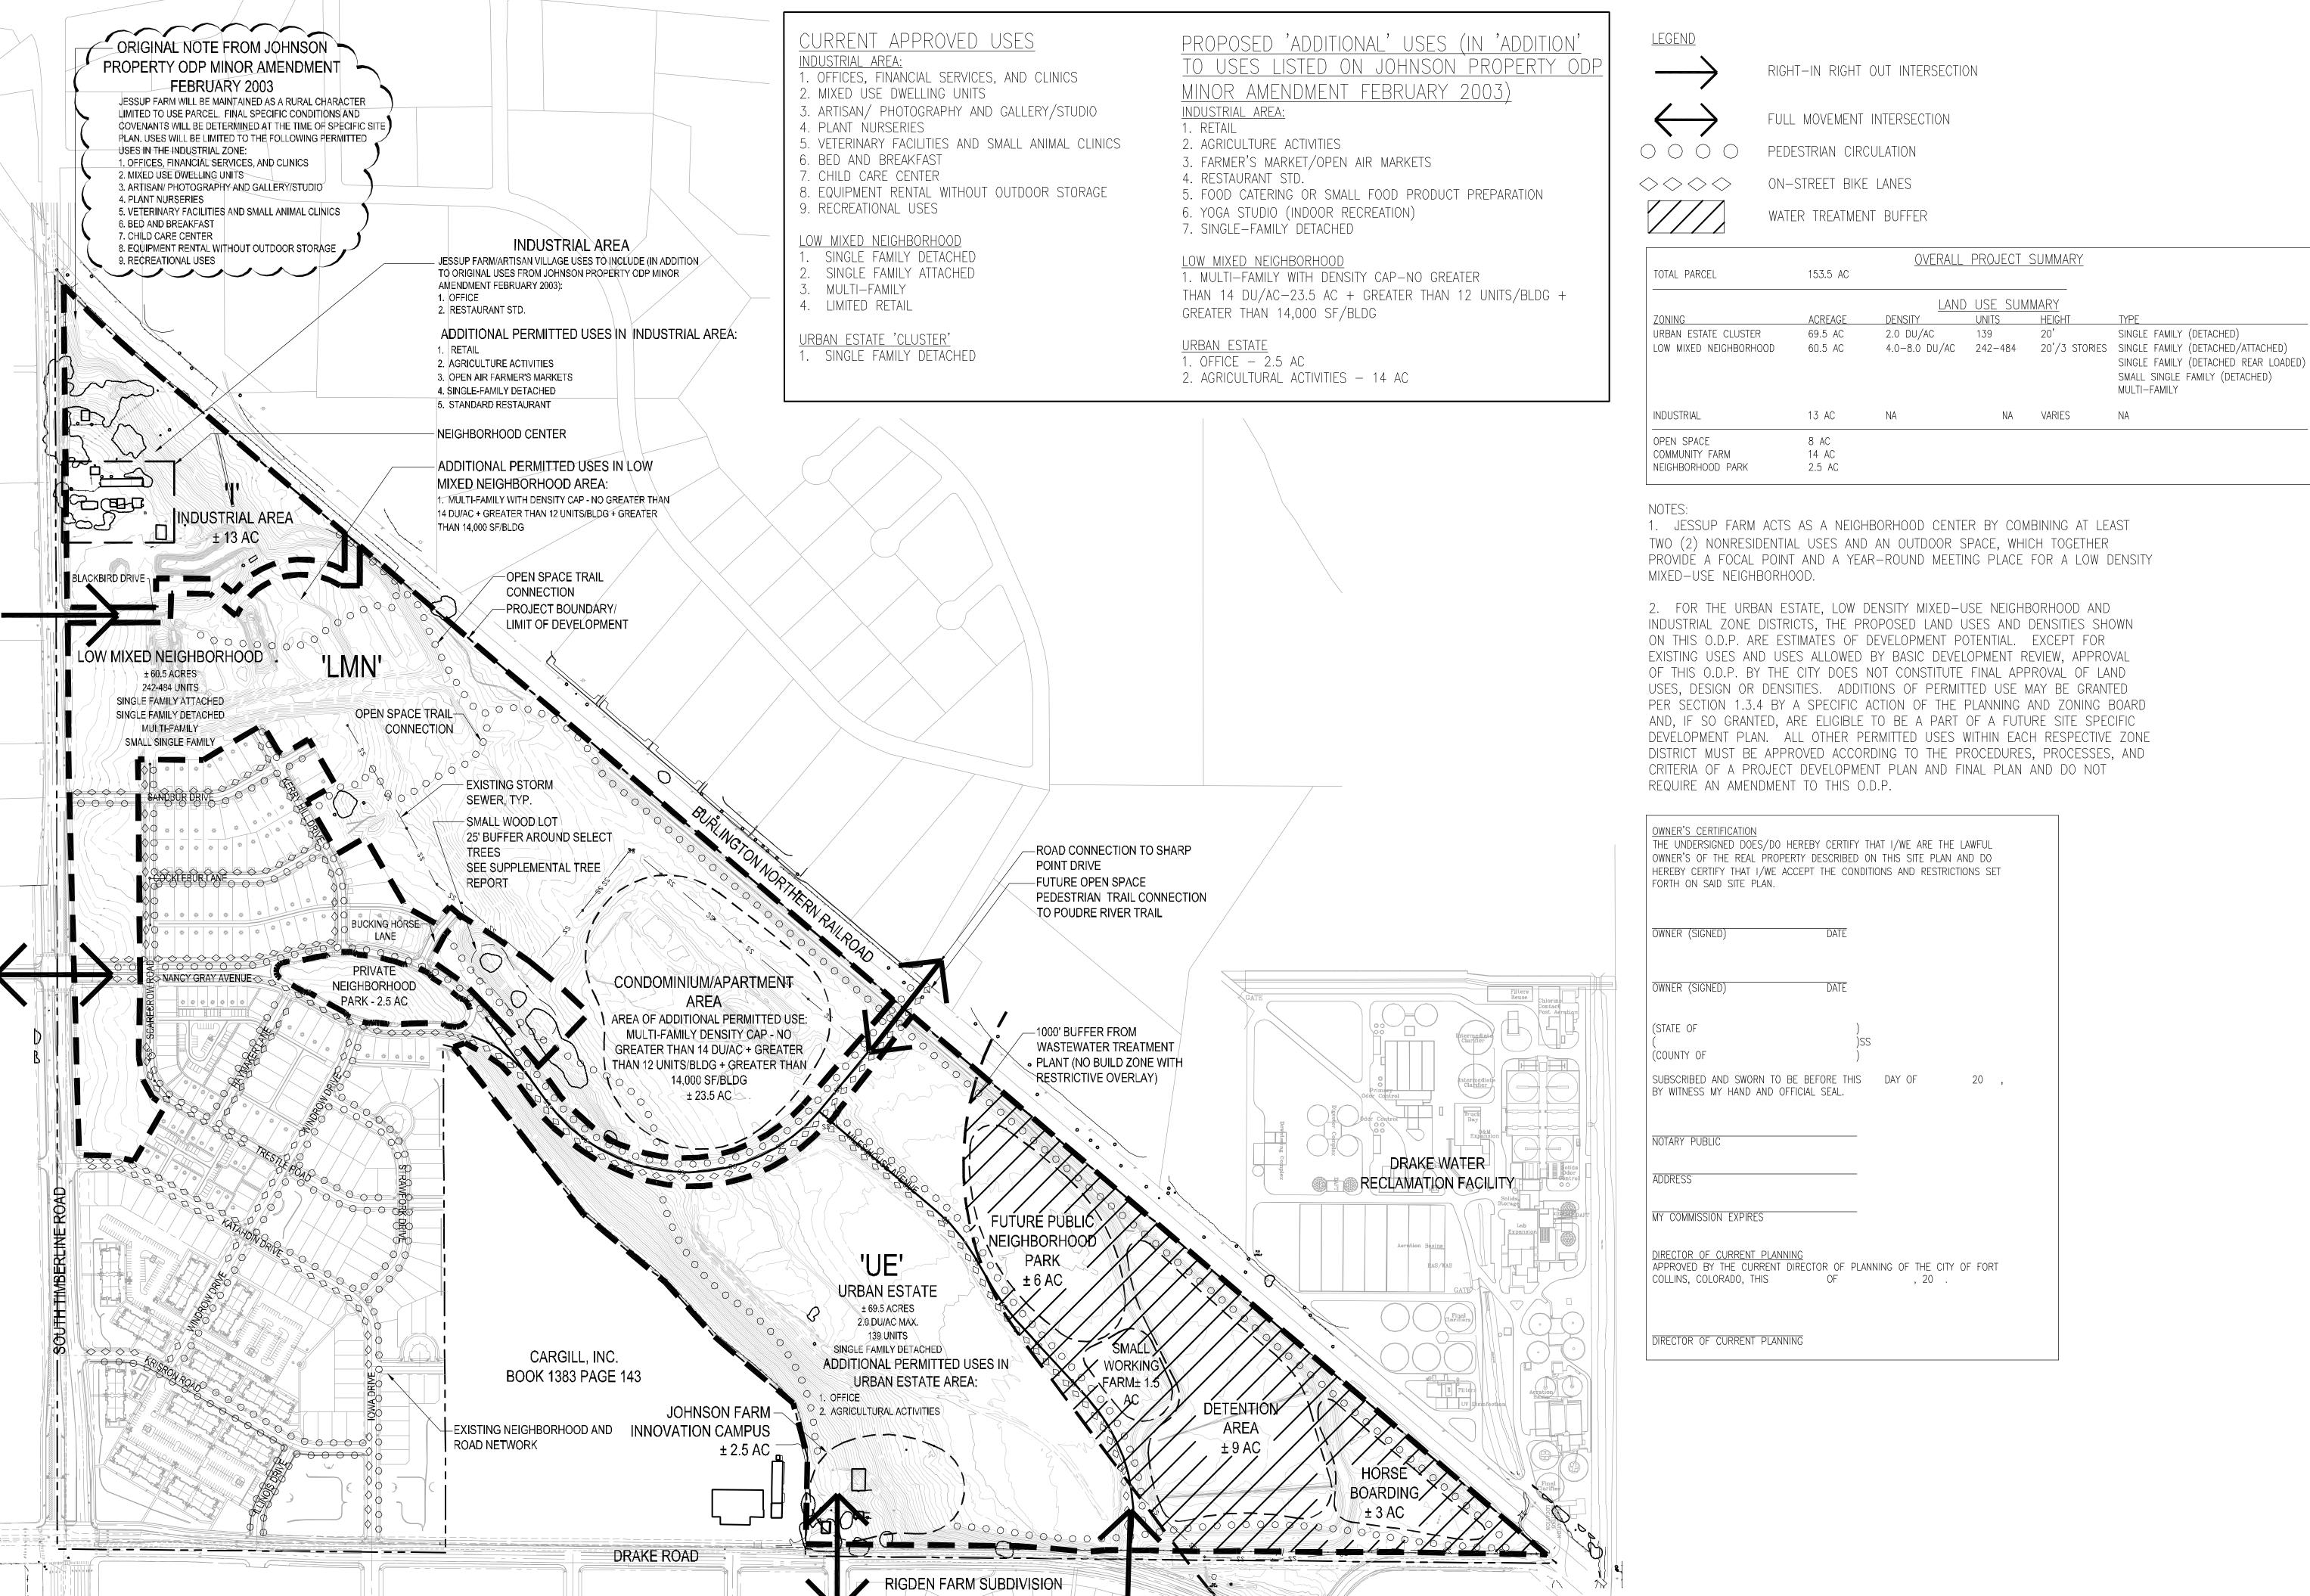


500' NORTH

0 125' 250'

OVERALL DEVELOPMENT PLAN

Date: 5/30/2012 Drawn By: JB/JS Checked By: CR/PM


ODP

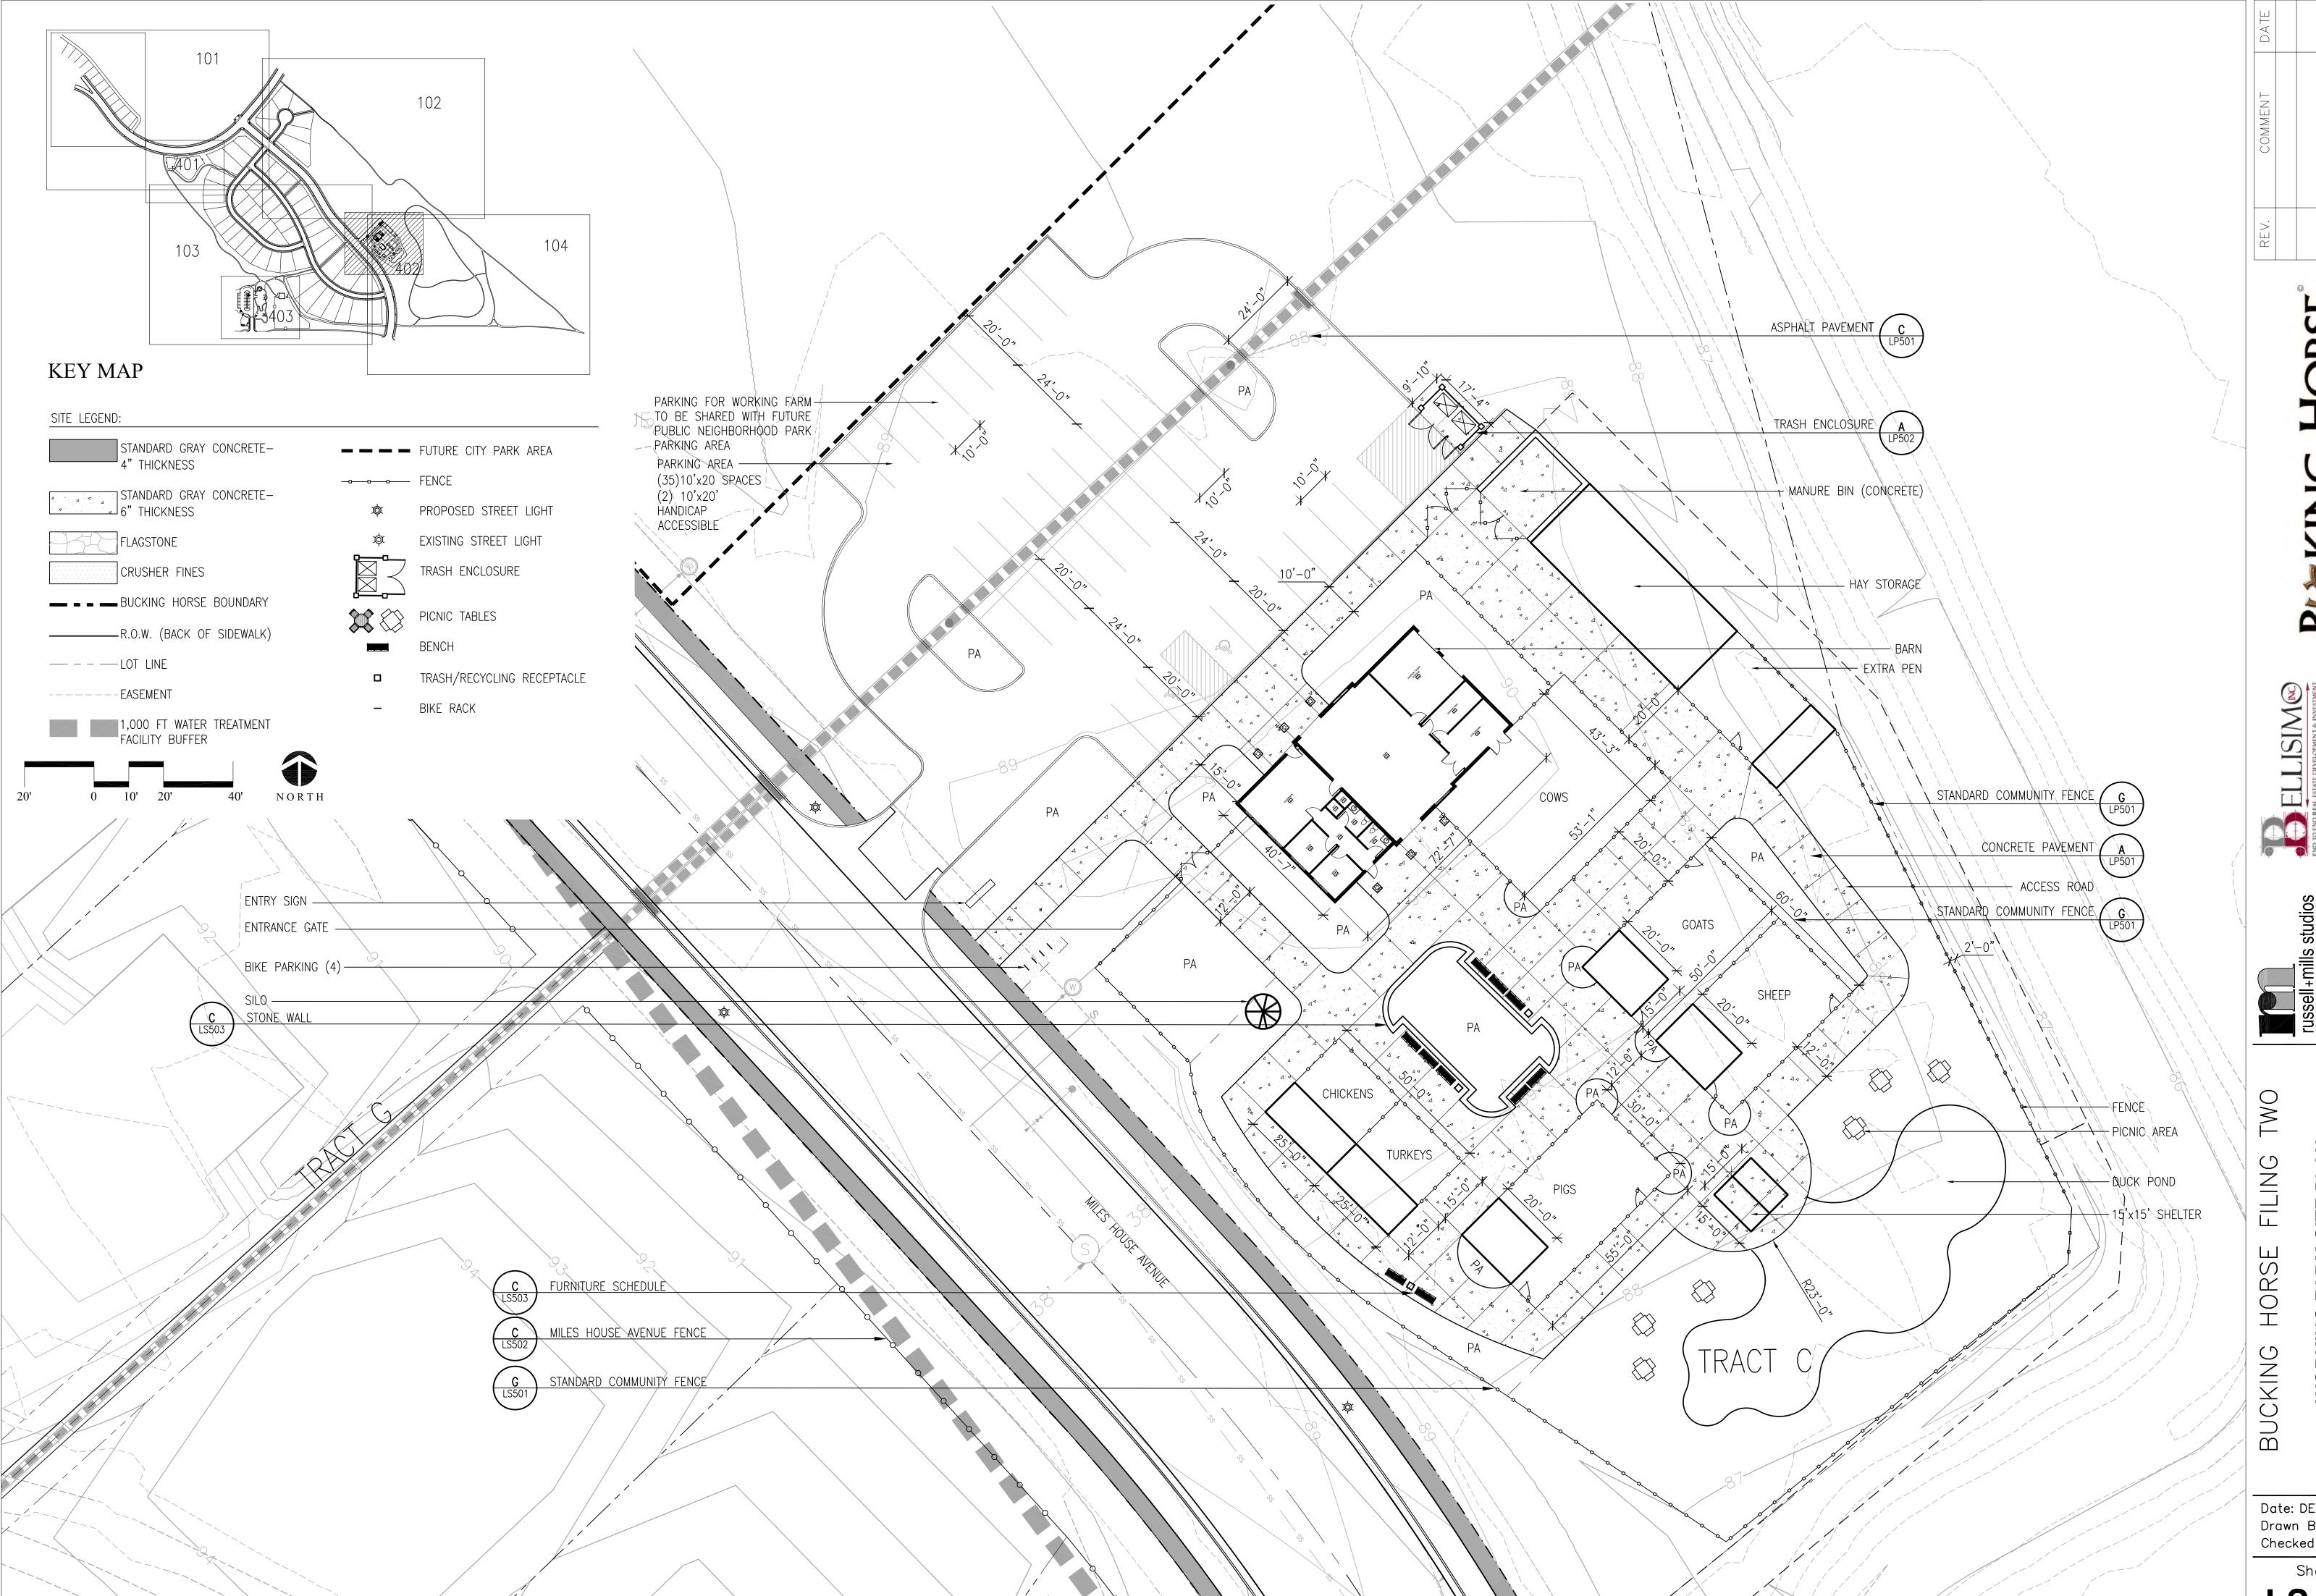


Date: DEC 14, 2012 Drawn By: SL Checked By: CR

Sheet

LS402

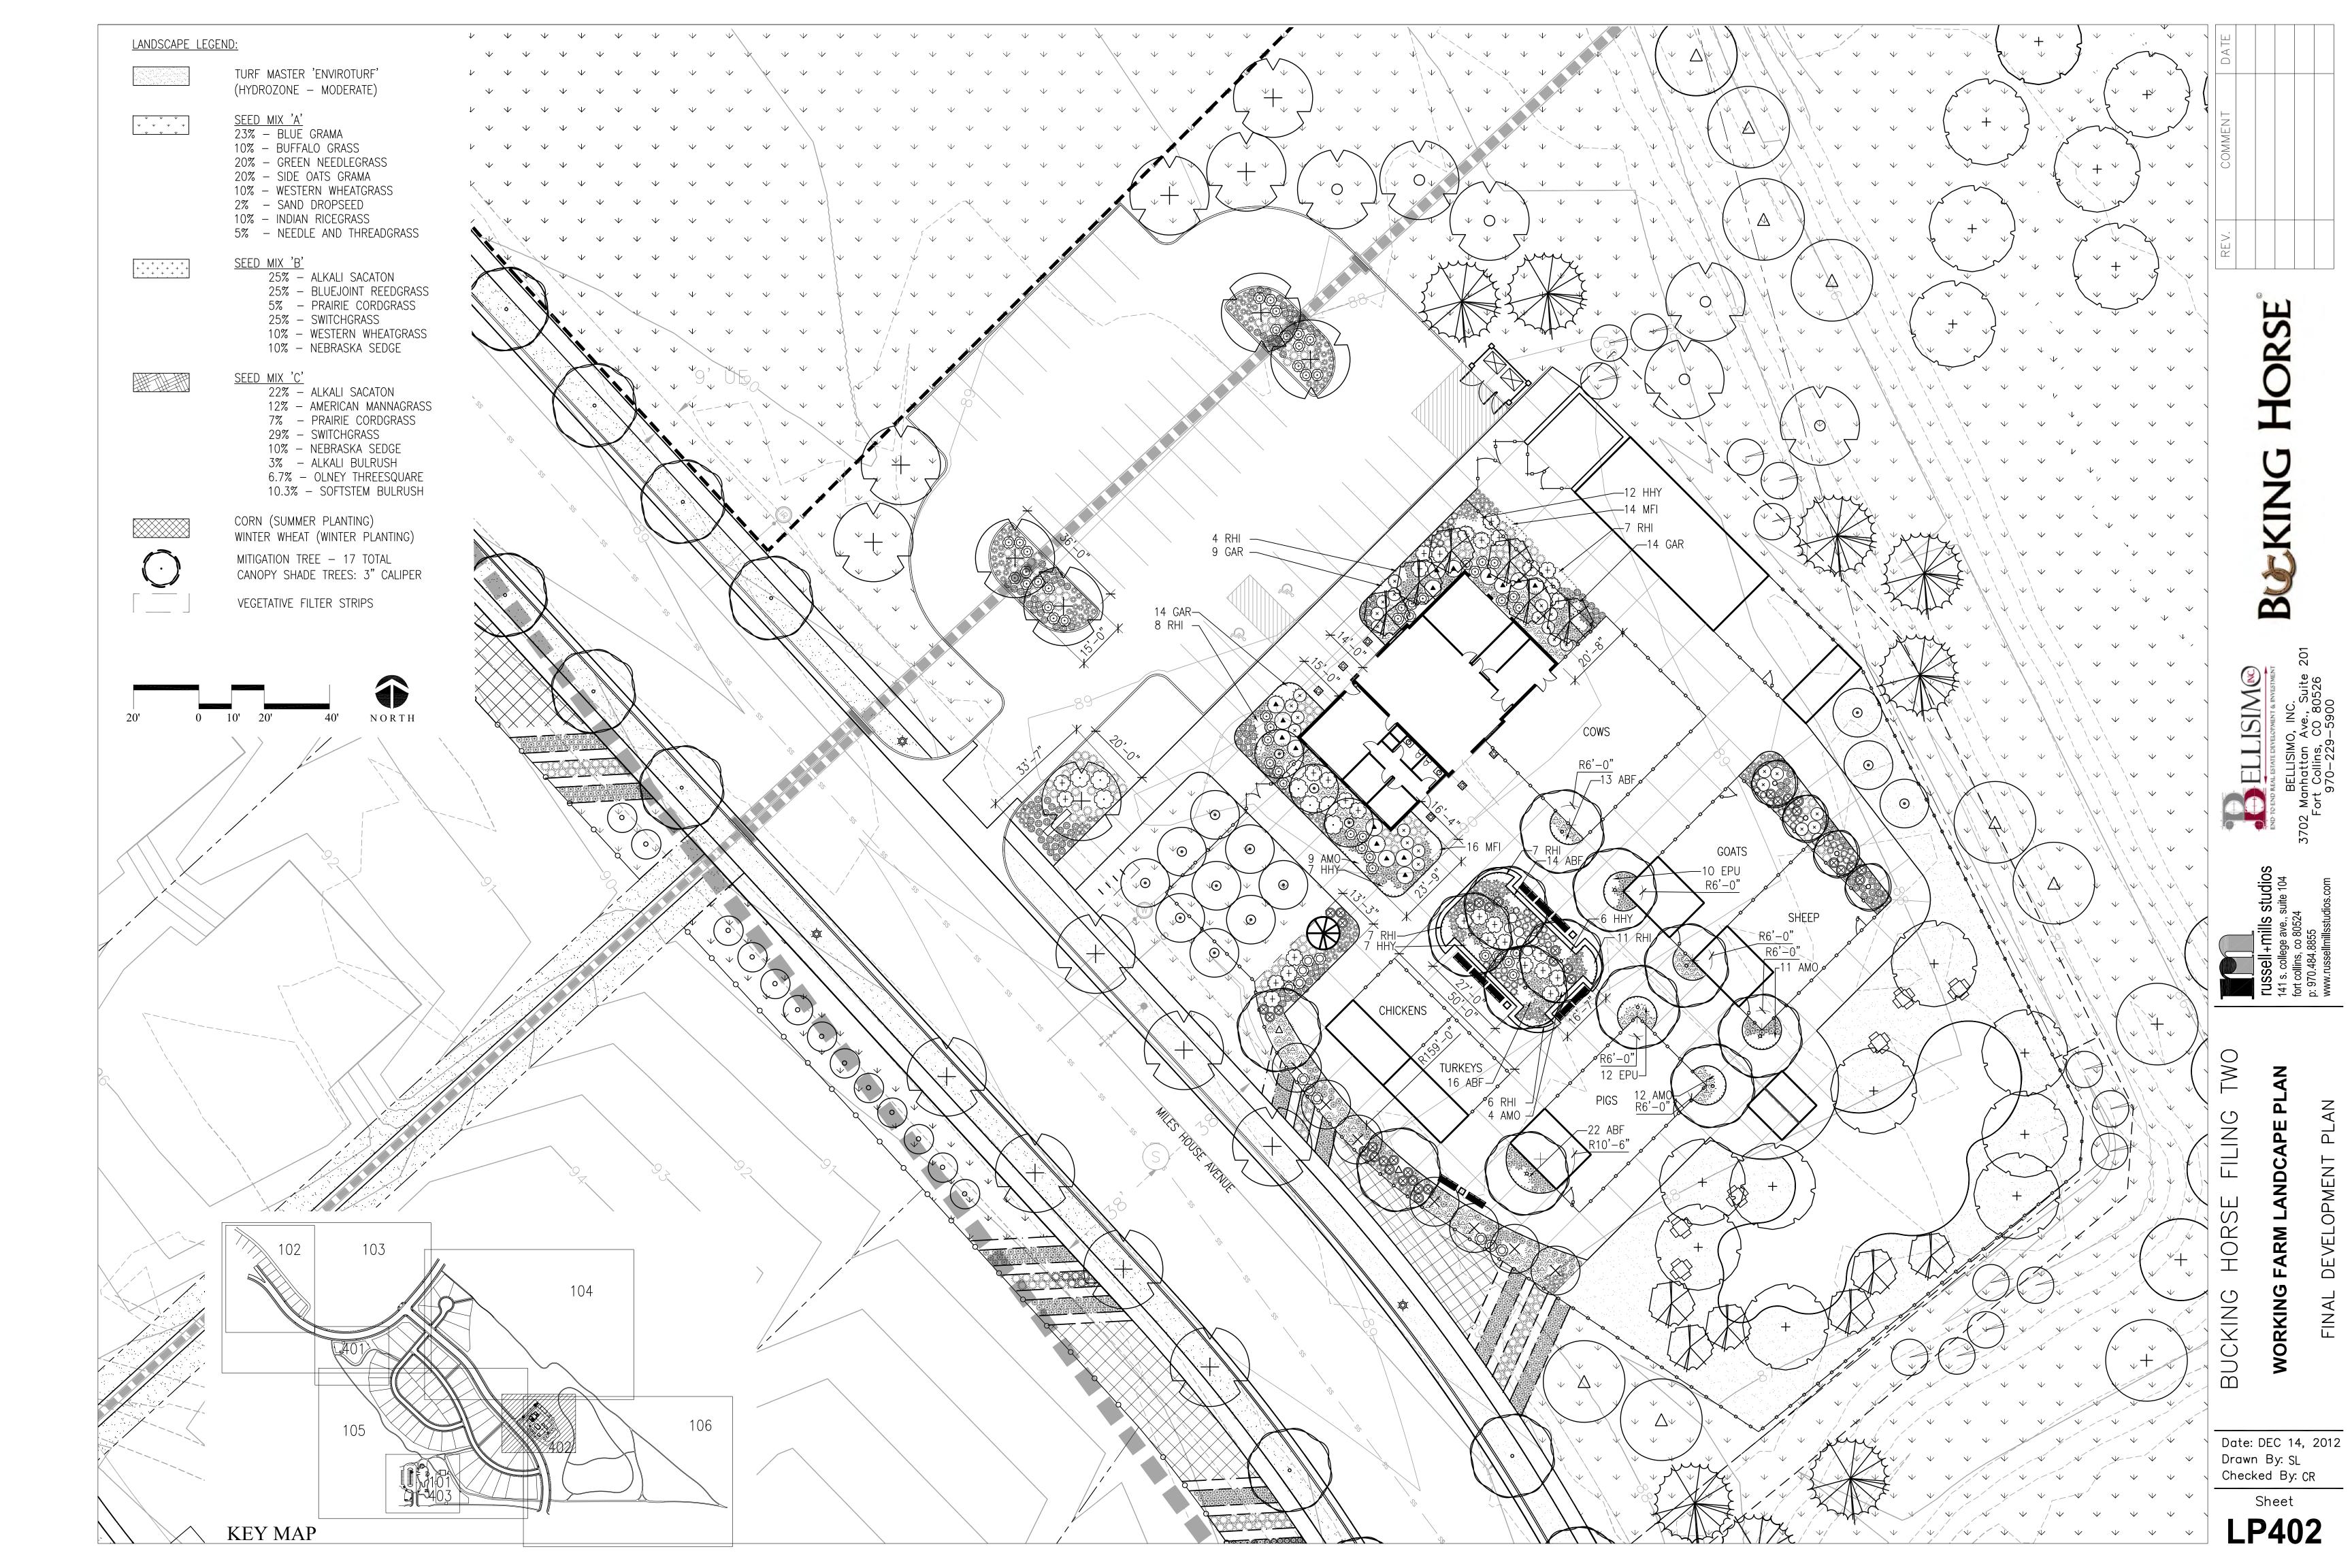

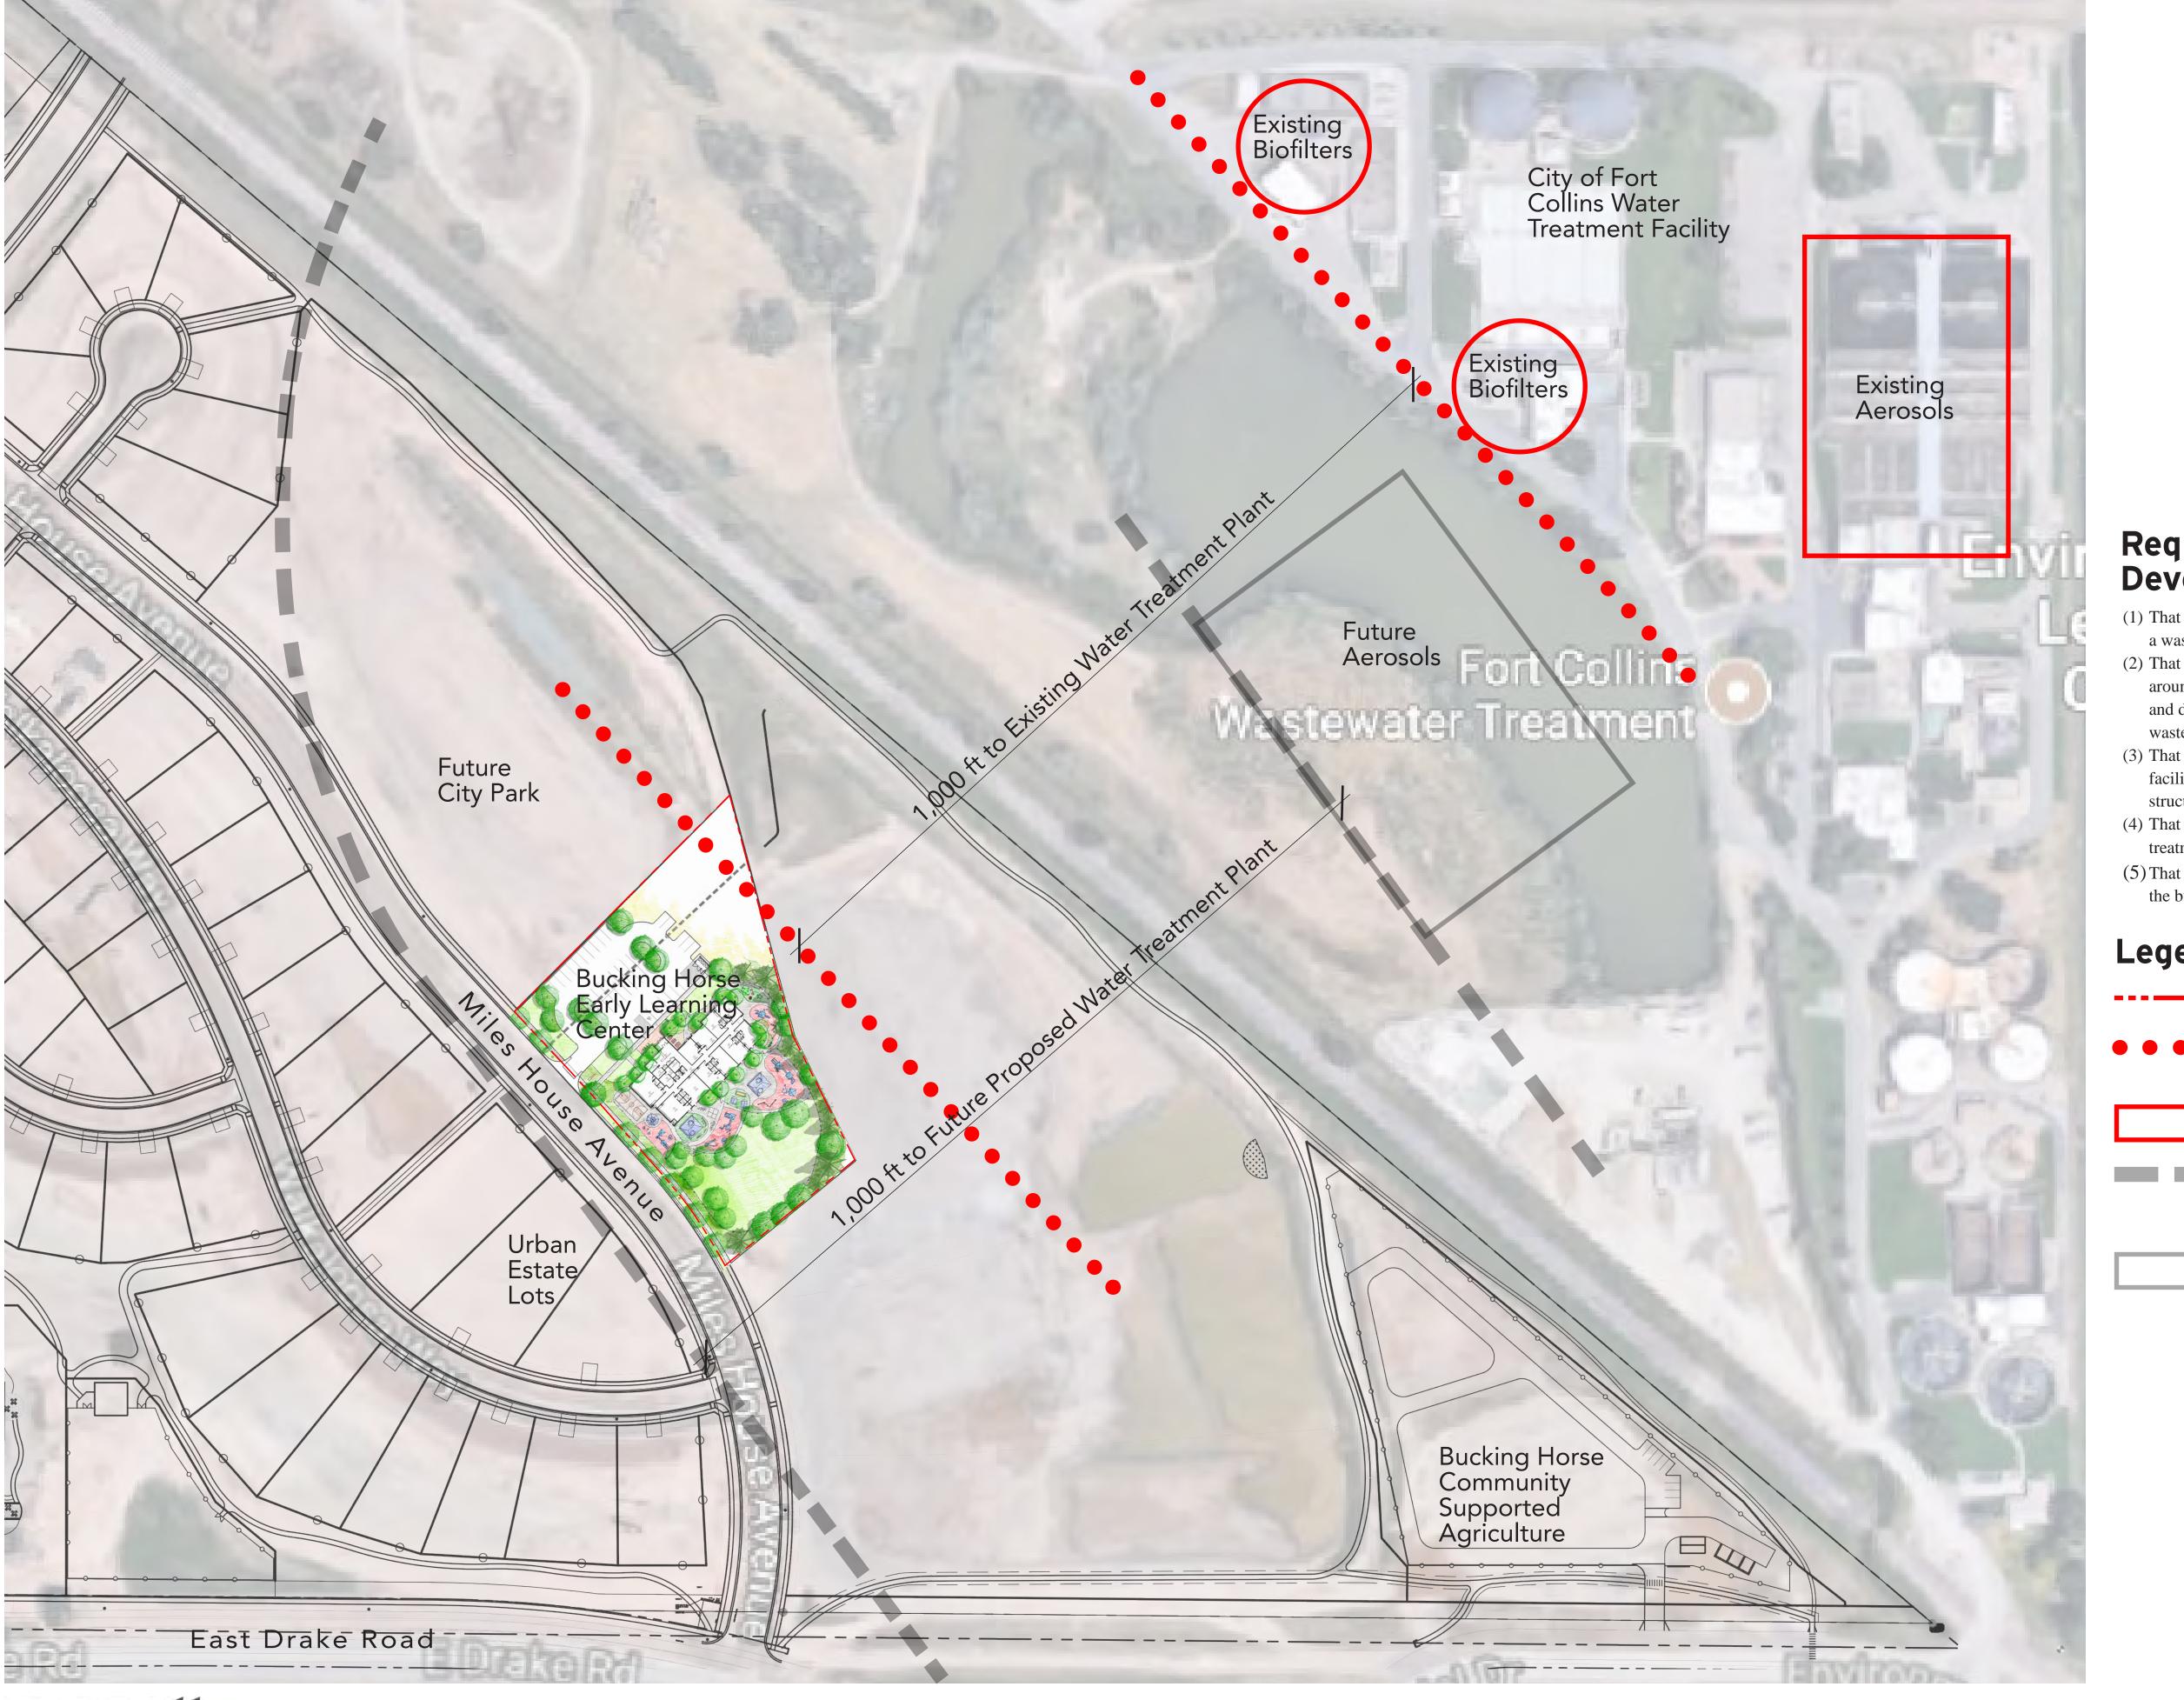

Requirements from FC Utilities for Development:

- (1) That the applicant shall acknowledge that the proposed development is located next to a wastewater treatment works;
- (2) That the minimum mitigation required shall include large continuous shrub beds around the facility building and outside play areas and installation of large evergreen and deciduous trees to create a vegetative buffer from odor and aerosol drift from the wastewater treatment facility;
- (3) That the applicant shall acknowledge that operation of the wastewater treatment facility may occasionally result in odors that may be detected by inhabitants of structures within the buffer;
- (4) That the applicant shall acknowledge that future expansion of the wastewater treatment facility may result in a further reduction of the 1000' buffer; and
- (5) That the applicant, and its successors and assigns, shall inform all future tenants of the building about these mitigation provisions.

Legend:

- --- Property line (109,089 sf / 2.5 ac)
- Current 1,000' Water Treatment Plant buffer
- **Current Water Treatment Facilities**
- Future 1,000' Water Treatment Plant buffer (based off of future expansion of facility part of Filing 4 document set)
 - Future Water Treatment Facilities







Land Use Code Requirements:

Existing Zone District:

Urban Estates

Permitted Uses:

Child Care Centers

Vehicle Parking: whichever requires the greatest number of parking spaces

1 parking space / 4 seats (176 kids) = 44 spaces

2 parking spaces / 3 employees (25 staff) = 17 spaces

1 parking space / 1,000 SF of floor area (11,000 SF) = 11 spaces

Bike Parking:

1/3,000 sf (minimum of 4), 100% fixed = 4

Outdoor Play Area:

(more than 15 children) 75 sf/child for 33% of the child capacity of the center

Capacity = 176 children 33% = 58 children Outdoor play area required = 4,350 SF

Fencing:

Fencing shall be 6' height chain link fence with vegetation screening, densely planted.

Legend:

--- Property lot line (109,089 sf / 2.5 ac)

1,000' Water Treatment Plant buffer (based off of future expansion of facility - part of Filing 4 document set)

• • • • 1,000' Water Treatment Plant buffer (based off of current facility)



