Conceptual Review Agenda


Schedule for 06/07/18 to 06/07/18

281 Conference Room A

Thursday, June 7, 2018					
Time	Project Name	Applicant Info	Project Description		
9:30	1314 Red Cedar Circle CDR180035	Stacy Kubeldis (626) 826-9321 stacy.kubeldis@gmail.com	This is a request to add an additional 10 feet to an existing 90 foot tall cellular tower with exposed mounted antennas. The additional 10 feet would accommodate a 3 foot diameter dish. The proposed project is within the Industrial (I) zone district and is subject to Administrative (Type 1) review.	Planner DRC	Ted Shepard Todd Sullivan
10:15	2155 Midpoint Dr CDR180036	Deanne Frederickson (970) 534-9095 deanne.frederickson@baselinecorp.com	This is a request to construct an open lean-to structure at 2155 Midpoint Dr (parcel #8720220002). The proposed facility would be used store and distribute building materials. A u-shaped access drive is proposed with two connections to Midpoint Dr. The property is currently developed. The proposed project is within the Employment (E) zone district and is subject to Administrative (Type 1) review.	Planner DRC	Clay Frickey Tenae Beane
11:00	OTAC Crossfit CDR180037	Krisin Slattery (970) 690-2213 kristin.slattery@colostate.edu	This is a request to construct a two-story, 7,000 square foot indoor recreation facility at 748 N College Ave (parcel #9701319002). The proposed project would be accessed along the north by extending Pascal St to the west. Twenty-one parking spaces are located along the west and south. The proposed project is within the Service Commercial (CS) zone district and is subject to Administrative (Type 1) review.	Planner DRC	Pete Wray Brandy Bethuem- Harras

Agenda as of 05/30/18 at 8:50 am Page 1 of 1

1314 Red Cedar Circle Cellular Equipment

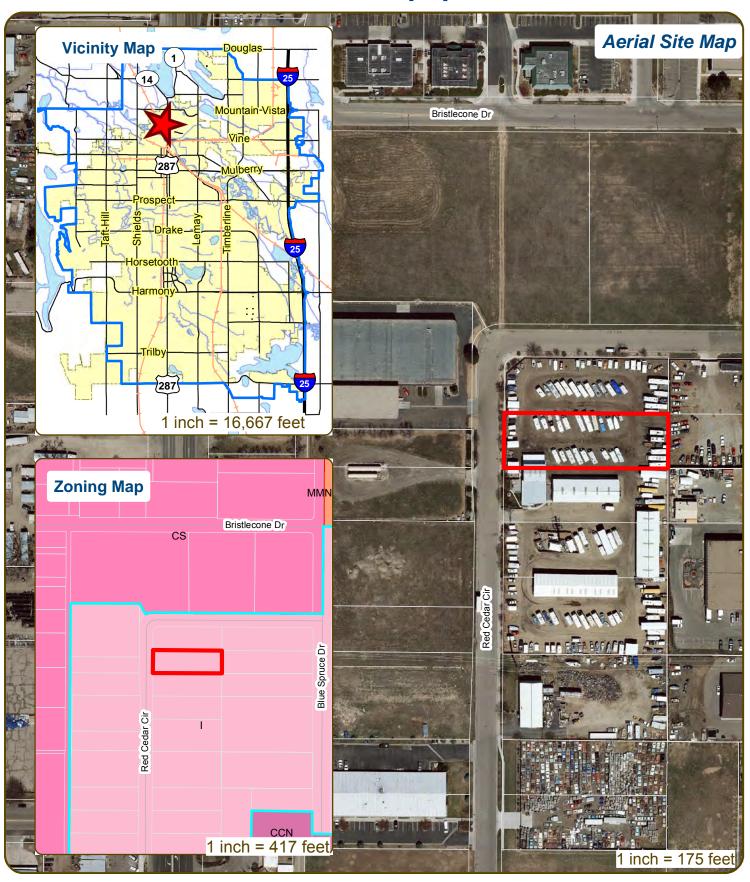

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CONCEPTUAL REVIEW: APPLICATION

General Information

All proposed development projects begin with Conceptual Review. Anyone with a development idea can schedule a Conceptual Review meeting to get feedback on prospective development ideas. At this stage, the development idea does not need to be finalized or professionally presented. However, a sketch plan and this application must be submitted to City Staff prior to the Conceptual Review meeting. The more information you are able to provide, the better feedback you are likely to get from the meeting. Please be aware that any information submitted may be considered a public record, available for review by anyone who requests it, including the media.

Conceptual Reviews are scheduled on three Monday mornings per month on a "first come, first served" basis. One 45 meeting is allocated per applicant and only three conceptual reviews are done each Monday morning. Conceptual Review is a free service. Complete applications and sketch plans must be submitted to City Staff no later than 5 pm, two Tuesdays prior to the meeting date. Application materials must be e-mailed to currentplanning@fcgov.com. If you do not have access to e-mail, other accommodations can be made upon request.

At Conceptual Review, you will meet with Staff from a number of City departments, such as Community Development and Neighborhood Services (Zoning, Current Planning, and Development Review Engineering), Light and Power, Stormwater, Water/Waste Water, Advance Planning (Long Range Planning and Transportation Planning) and Poudre Fire Authority. Comments are offered by staff to assist you in preparing the detailed components of the project application. There is no approval or denial of development proposals associated with Conceptual Review. At the meeting you will be presented with a letter from staff, summarizing comments on your proposal.

BOLDED ITEMS ARE REQUIRED *The more info provided, the more detailed your comments from staff will be.*

Contact Name(s) and Role(s) (Please identify whether Consultant or Owner, etc) Consultant

Business Name (if applicable)	Mastec
Your Mailing Address	3350 E. Birch Street #101 Brea, CA 92821
Phone Number <u>626-826-9321</u>	Email Address <u>stacy.kubeldis@gmail.com</u>
	cel # if no address)1314 Red Cedar Circle Fort Collins, CO_80525
Description of Proposal (attach a	dditional sheets if necessary) Purposed Scope of Work:
10' extension to an existing cell to	ower
3' dish at 95' with 2 runs of EW-	90 Cabling.
Proposed Use	Existing UseExisting Cell Tower
Total Building Square Footage	S.F. Number of Stories Lot Dimensions
Age of any Existing Structures _	Tower was built 8/31/2001
Info available on Larimer County's We	osite: http://www.co.larimer.co.us/assessor/query/search.cfm od quality, color photos of all sides of the structure are required for conceptual.
	? □ Yes ፮ No If yes, then at what risk is it?eb.fcgov.com/redirect/default.aspx?layerTheme=Floodplains.
· · · · · · · · · · · · · · · · · · ·	all work is withing the existing lease area, please refer to site plans S.F. ding, pavement, or etc. that will cover existing bare ground to be added to the site)

Suggested items for the Sketch Plan:

Property location and boundaries, surrounding land uses, proposed use(s), existing and proposed improvements (buildings, landscaping, parking/drive areas, water treatment/detention, drainage), existing natural features (water bodies, wetlands, large trees, wildlife, canals, irrigation ditches), utility line locations (if known), photographs (helpful but not required). Things to consider when making a proposal: How does the site drain now? Will it change? If so, what will change?






WILCOX AND COLLEGE 1314 RED CEDAR CIRCLE FORT COLLINS, COLORADO 80525 FA# 10127031 **NOVA PROJECT ID: WES-MW-06806** COL03088

SPECIAL INSPECTIONS

- CONCRETE BOLTS INSTALLED IN CONCRETE
- CONCRETE MOMENT-RESISTING SPACE FRAME REINFORCING STEEL AND PRESTRESSING STEEL WELD TESTING DUCTILE MOMENT-RESISTING STEEL FRAME

- 2 WELD TESTING DUCTILE MOMENT-RESISTING STEEL FRAM
 3 WELDING REINFORCING STEEL
 HIGH-STRENGTH BOLTING
 STRUCTURAL MASONRY
 REINFORCED GYPSUM CONCRETE
 INSULATING CONCRETE FILL
 SPRAY-APPLIED FIREPROOFING
 DEEP FOUNDATIONS (PILING, DRILLED & CAISSONS)
 SHOTICPETE

5.3 6 7 8 9 10	CONCRETE BOLTS INSTALLED IN CONCRETE CONCRETE MOMENT—RESISTING SPACE FRAME REINFORCING STEEL AND PRESTRESSING STEEL ALL STRUCTURAL WELDING WELD TESTING DUCHILE MOMENT—RESISTING STEEL FRAME WELDING REINFORCING STEEL HIGH—STRENGTH BOLTING STRUCTURAL MASONRY REINFORCED GYPSUM CONCRETE INSULATING CONCRETE FILL SPRAY—APPLIED FIREPROOFING DEEP FOUNDATIONS (PILING, DRILLED & CAISSONS) SHOTCRETE	13.2 13.3	VERIFY SOIL CONDITIONS ARE SUBSTANTIALLY IN CONFORMANCE WITH THE SOIL INVESTIGATION REPORT VERIFY THAT FOUNDATION EXCAVATIONS EXTEND TO PROPER DEPTH AND BEARING STRATA PROVIDE SOIL COMPACTION TEST RESULTS, DEPTH OF FILL, RELATIVE DENSITY, BEARING VALUES PROVIDE SOIL EXPANSION TEST RESULTS, EXPANSION INDEX, RECOMMENDATIONS FOR FOUNDATIONS, ON-GRADE FLOOR SLAB DESIGN FOR EACH BUILDING SITE SMOKE CONTROL SYSTEM SPECIAL CASES (DESCRIEE) OFF-STIE FABRICATION OF BUILDING COMPONENTS OTHER SPECIAL INSPECTIONS AS REQUIRED BY DESIGNER
NO.	DESCRIPTION OF TYPE OF INSPECTION REQUIRED, L	OCATIO	N, REMARKS.
			<u> </u>
			·

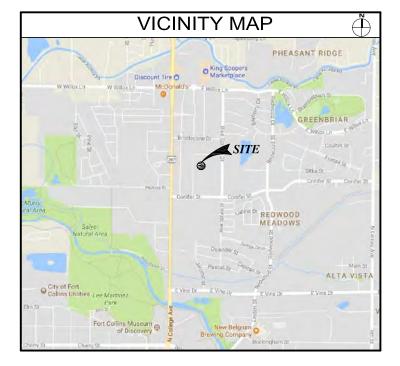

CONSULTANT TEAM

CLIENTS REPRESENTATIVE:

MASTEC NETWORK SOLUTIONS

725 SOUTH REVERE PARKWAY, SUITE 100

CENTENNIAL, COLORADO 80112 CONTACT: CHRISTINA MICHAUD (480) 477-4165 PHONE:

ARCHITECT:

JEFFREY ROME & ASSOCIATES

131 INNOVATION DRIVE IRVINE. CALIFORNIA 92617 SUITE: 100

CONTACT: ANITA JEN PHONE: (949) 760-3929 (949) 760-3931

SITE ACQUISITION:

131 INNOVATION DRIVE IRVINE, CALIFORNIA 92617 SUITE:

CONTACT: STACY KUBELDIS (949) 760-3929 PHONE: (949) 760-3931

DEVELOPMENT SUMMARY

APPLICANT:

188 INVERNESS DRIVE WEST: SUITE 400 ENGLEWOOD, COLORADO 80112

LAND OWNER: JERALD H. RUSSELL

TOWER OWNERS AMERICAN TOWER CORPORATION

OTHER ON-SITE TELECOM FACILITIES:

ASSESSORS PARCEL NUMBER: 97012-14-004

LATITUDE: 40° 36' 17.5" N 40.604861* LONGITUDE:

LAT/LONG TYPE: ELEVATION ±4991.0' AMSL

FXISTING ZONING:

PROPOSED OCCUPANCY:

PROPOSED PROJECT AREA: NO INCREASE IN S.F. EXISTING TYPE OF CONSTRUCTION: TYPE V-N

PROPOSED TYPE OF CONSTRUCTION: TYPE V-N EXISTING OCCUPANCY:

JURISDICTION: CITY OF FORT COLLINS

SHEET INDEX

TITLE SHEET SPECIFICATIONS AND NOTES

OVERALL SITE PLAN
SITE PLAN
SITE PLAN
ENLARGED SITE AND EQUIPMENT PLAN
EXISTING AND PROPOSED ELEVATIONS
ANTENNA DETAILS
SPECIFICATIONS
ANTENNA MOLINITING DETAILS

ANTENNA MOUNTING DETAILS ANTENNA MOUNTING DETAILS ANTENNA MOUNTING DETAILS

MONOPOLE EXTENSION REFERENCE SHEETS

REF-1 REFERENCE SHEET REF-2 REFERENCE SHEET REF-3 REFERENCE SHEET

APPLICABLE CODES

ALL WORK SHALL COMPLY WITH THE FOLLOWING APPLICABLE CODES:

INTERNATIONAL BUILDING CODE, 2012 EDITION INTERNATIONAL MECHANICAL CODE, 2012 EDITION INTERNATIONAL ENERGY CONSERVATION CODE, 2012 EDITION NATIONAL ELECTRICAL CODE, 2014 EDITION INTERNATIONAL PLUMBING CODE 2012 EDITION

INTERNATIONAL FUEL GAS CODE, 2012 EDITION NATIONAL FIRE PROTECTION ASSOCIATION STANDARDS, 2002-2006 EDITIONS

N THE EVENT OF CONFLICT, THE MOST RESTRICTIVE CODE SHALL PREVAIL

PRECON NOTES

CONTACT AMERICAN TOWER FIFLD TECHNICIAN TO SCHEDULE PRE-CON 48 HOURS PRIOR TO REQUESTED MOBILIZATION ON SITE.

MASTEC TO CONFIRM COMPLETION OF TOWER MODIFICATION DATED 02/09/18 PREPARED BY ATC PRIOR TO START OF CONSTRUCTION; SEE REFERENCE SHEETS.

PROJECT DESCRIPTION

AT&T MOBILITY PROPOSES TO MODIFY AN EXISTING UNMANNED WIRELESS COMMUNICATIONS FACILITY. THIS MODIFICATION WILL CONSIST OF THE FOLLOWING:

- INSTALL NEW 3'-0" MICROWAVE ANTENNA AT A 95'-0" RAD CENTER.
 INSTALL NEW (2) RUNS OF EW-90 WAVEGUIDE CABLES.

ACCESSIBILITY DISCLAIMER

THIS PROJECT IS AN UNOCCUPIED WIRELESS PCS TELECOMMUNICATIONS FACILITY AND IS EXEMPT FROM DISABLED ACCESS REQUIREMENTS.


SCALE

THE DRAWING SCALES SHOWN IN THIS SET REPRESENT THE CORRECT SCALE ONLY WHEN THESE DRAWINGS ARE PRINTED IN A 24"X36" FORMAT, IF THIS DRAWING SET S NOT 24"X36", THIS SET IS NOT TO SCALE

Jeffrey Rome | ASSOCIATES architecture | telecommunications 131 Innovation Drive; Suite 100 Irvine, California 92617 tel 949.760.3929 | fax 949.760.3931

PROPRIETARY INFORMATION

THE INFORMATION CONTAINED IN THIS SET OF CONSTRUCTION DOCUMENTS IS PROPRIETARY BY NATURE. ANY USE OR DISCLOSURE OTHER THAN THAT WHICH RELATES TO AT&T WIRELESS IS STRICTLY PROHIBITED.

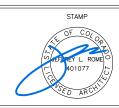

Network Solutions

12/29/17
DATE
02/22/18
DATE
02/22/18
DATE
01/09/18
DATE
DATE

PROJECT NAME MICROWAVE UPGRADE

SITE NAME WILCOX AND COLLEGE

FA NUMBER 10127031

1314 RED CEDAR CIRCLE

DRAWING DATES

12/27/17 90% CD REVIEW (P1-B1)

SHEET TITLE

TITLE SHEET

T-1

GENERAL SPECIFICATIONS

- A201 "GENERAL CONDITIONS OF THE CONTRACT FOR CONSTRUCTION" ARE INCLUDED IN THESE SPECIFICATIONS AS IF COMPLETELY REPRODUCED HEREIN.

 TOLLET FACILITIES AS REQUIRED BY THE PROPERTY OW AT&T MOBILITY, AND THE CITY OR GOVERNING AGENCY.
- THIS FACILITY IS AN UNOCCUPIED PCS TELECOMMUNICATIONS SITE AND IS 21. THE GENERAL CONTRACTOR IS RESPONSIBLE FOR REDLINING THE EXEMPT FROM DISABLED ACCESS REQUIREMENTS.
- PRIOR TO THE SUBMISSION OF BIDS, THE CONTRACTORS PARTICIPATING 3. PRIOR TO THE SUBMISSION OF BIDS, THE CONTRACTORS PARTICIPATING SHALL WRIT THE JOB SITE AND FAMILIARIZE THEMSELVES WITH ALL FIELD CONDITIONS AFFECTING THE PROPOSED PROJECT INCLUDING DEMOLITION, ELECTRICAL, MECHANICAL AND STRUCTURAL INSTALLATIONS, AS WELL AS WITH THE CONSTRUCTION AND CONTRACT DOCUMENTS AND SHALL CONFIRM THAT THE PROJECT CAN BE ACCOMPLISHED AS SHOWN PRIOR TO PROCEEDING WITH CONSTRUCTION SHOULD ANY ERRORS, OMISSION, OR DISCREPANCIES BE FOUND, THE GENERAL CONTRACTOR SHALL IMMEDIATELY NOTIFY ATAT MOBILITY CONSTRUCTION MANAGER AND THE ARCHITECT IN WRITING. IN THE EVENT OF DISCREPANCIES THE CONTRACTOR SHALL INCLUDE THE MORE COSTLY OR EXTENSIVE WORK IN THE BID JUNIESS SPECIFICALLY DIRECTED OTHERWISE. IF A DISCREPANCY EXISTS AND THE PROJECT MANAGER AND ARCHITECT ARE NOT NOTIFIED. THE GENERAL CONTRACTOR SHALL BE HELD RESPONSIBLE FOR ALL COSTS INCURRED TO REPAIR OR CORRECT ALL PROBLEMS THAT RESULT.
- DRAWINGS SHALL NOT BE SCALED. THESE DRAWINGS ARE INTENDED TO BE DRAWINGS SPALE AUT DE SOCIED. INFESS DRAWINGS ARE INVENDED TO DIGGRAMMATIC ONLY, FIGURED DIMENSIONS HAVE PRECEDENCE OVER DRAWING SCALE AND DETAIL DRAWINGS HAVE PRECEDENCE OVER SMALL SCALE DRAWINGS. CONTRACTOR SHALL CHECK ACCURACY OF ALL DIMENSIONS IN THE FIELD. UNLESS SPECIFICALLY NOTED, DO NOT FABRICATE ANY MATERIALS, OR BEGIN ANY CONSTRUCTION UNTIL THE ACCURACY OF DRAWING DIMENSIONS HAS BEEN VERIFIED AGAINST ACTUA
- THE CONTRACTOR SHALL INCLUDE IN HIS OR HER BID ALL MATERIALS, EQUIPMENT, APPURTENANCES AND LABOR NECESSARY TO COMPLETE THE WORK AS INDICATED OR IMPLIED BY THESE DRAWINGS.
- PROPERTY OWNER'S PREFERRED HOURS TO AVOID DISRUP NORMAL ACTIVITY.

 PROPERTY OWNER'S PREFERRED HOURS TO AVOID DISRUP NORMAL ACTIVITY.

 PROPERTY OWNER'S PREFERRED HOURS TO AVOID DISRUP NORMAL ACTIVITY.

 25. ALL EXPOSED METAL SHALL BE HOT-DIPPED GALVANIZED. WITHIN CUSTOMARY TRADE PRACTICE. IF WORK IS PERFORMED, IT WILL BE ASSUMED THAT THERE IS NO OBJECTION TO ANY DETAIL. DETAILS ARE INTENDED TO SHOW THE END RESULT OF THE DESIGN. MINOR MODIFICATIONS MAY BE REQUIRED TO SUIT JOB CONDITIONS, AND SHALL BE INCLUDED AS PART OF THE WORK.
- EXISTING ELEVATIONS AND LOCATIONS TO BE JOINED SHALL BE VERIFIED BY THE CONTRACTOR BEFORE CONSTRUCTION. IF THEY DIFFER FROM THOSE SHOWN ON THE PLANS, THE CONTRACTOR SHALL NOTIFY THE ATA'T MOBILITY CONSTRUCTION MANAGER AND THE ARCHITECT SO THAT MODIFICATIONS CAN BE MADE BEFORE PROCEDEDING WITH THE WORK. BE MADE BEFORE PROCEEDING WITH THE WORK
- THE CONTRACTOR SHALL VERIFY ALL TELEPHONE & RADIO EQUIPMENT LAYOUTS, SPECIFICATIONS, PERFORMANCE, INSTALLATION AND FINAL LOCATIONS WITH ATAT MOBILITY CONSTRUCTION MANAGER PRIOR TO BEGINNING WORK. THE CONTRACTOR SHALL BE RESPONSIBLE FOR COORDINATING HIS WORK WITH ERICSSON RADIO SYSTEMS
- . ALL SYMBOLS & ABBREVIATIONS USED ON THE DRAWINGS ARE CONSIDERED CONSTRUCTION STANDARDS. IF THE CONTRACTOR HAS QUESTIONS REGARDING THEIR EXACT MEANING, THE AT&T MOBILITY CONSTRUCTION MANAGER AND THE ARCHITECT SHALL BE NOTIFIED FOR CLARIFICATION BEFORE THE CONTRACTOR PROCEEDS WITH THE WORK.
- THE CONTRACTOR SHALL OBTAIN AND PAY FOR PERMITS, LICENSES AND INSPECTIONS NECESSARY FOR PERFORMANCE OF THE WORK AND INCLUDE THOSE IN THE COST OF THE WORK TO AT&T MOBILITY.
- THE CONTRACTOR SHALL PROVIDE CONTINUOUS SUPERVISION WHILE ANY SUBCONTRACTORS OR WORKMEN ARE IN THE SITE AND SHALL SUPERVISE AND DIRECT ALL WORK, USING HIS BEST SKILL AND ATTENTION. HE SHALL BE SOLELY RESPONSIBLE FOR ALL CONSTRUCTION MEANS, METHODS, TECHNIQUES, PROCEDURES AND SEQUENCES AND FOR COORDINATING ALL PORTIONS OF THE WORK UNDER THE CONTRACT.
- WORKMANSHIP THROUGHOUT SHALL BE OF THE BEST QUALITY OF THE TRADE INVOLVED, AND SHALL MEET OR EXCEED THE FOLLOWING MINIMUM REFERENCE STANDARDS FOR QUALITY AND PROFESSIONAL CONSTRUCTION

NATIONAL ROOFING CONTRACTORS ASSOCIATION O'HARE INTERNATIONAL CENTER 10255 W. HIGGENS ROAD, SUITE 600 ROSEMONT, IL 60018

SMACNA SHEET METAL AND AIR CONDITIONING CONTRACTORS 4201 LAFAYETTE CENTER DRIVE CHATILLY, VA 22021-1209

INTERNATIONAL INSTITUTE FOR LATH AND PLASTER 820 TRANSFER ROAD ST. PAUL, MN 55114-1406

INSTALL ALL EQUIPMENT AND MATERIALS PER THE LATEST EDITION OF THE MANUFACTURER'S INSTALLATION SPECIFICATIONS UNLESS SPECIFICALLY OTHERWISE INDICATED, OR WHERE LOCAL CODES OR REGULATIONS TAKE

THE CONTRACTOR SHALL VERIFY, COORDINATE, AND PROVIDE A NECESSARY BLOCKING, BACKING, FRAMING, HANGARS OR OTHER SUPPORTS FOR ALL ITEMS REQUIRING THE SAME.

THE CONTRACTOR AND ALL SUBCONTRACTORS SHALL GIVE ALL NOTICES AND SHALL COMPLY WITH ALL APPLICABLE LOCAL CODES, REGULATIONS, LAWS AND ORDINANCES AS WELL AS STATE DEPARTMENT OF INDUSTRIAL REGULATIONS AND DIVISION OF INDUSTRIAL SAFETY (OSHA) REQUIREMENTS.

THE CONTRACTOR SHALL PROTECT THE PROPERTY OWNERS, AND AT&T MOBILITY PROPERTY FROM DAMAGE WHICH MAY OCCUR DURING CONSTRUCTION. ANY DAMAGE TO NEW AND EXISTING FINISHES, CONSTRUCTION, STRUCTURE, LANDSCAPING, CURBS, STAIRS, OR EQUIPMENT, ETC. SHALL BE IMMEDIATELY REPARED OR REPLACED TO THE SATISFACTION OF AT&T MOBILITY, AND THE PROPERTY OWNER'S REPRESENTATIVE AT THE EXPENSE OF THE CONTRACTOR

THE CONTRACTOR SHALL BE RESPONSIBLE FOR AND SHALL REPLACE OR REMEDY ANY FAULTY IMPROPER OR INFERIOR MATERIALS OF WORKMANSHIP OR ANY DAMAGE WHICH SHALL APPEAR WITHIN ONE YEAR AFTER THE COMPLETION AND ACCEPTANCE OF THE WORK BY AT&T MOBILITY UNDER THIS CONTRACT

IT SHALL BE THE RESPONSIBILITY OF THE GENERAL CONTRACTOR TO LOCATE ALL EXISTING UTILITIES, OR CONTACT AN OUTSIDE AGENCY TO LOCATE ALL EXISTING UTILITIES, WHETHER SHOWN HEREIN OR NOT, AND TO PROTECT THEM FROM DAWAGE. THE CONTRACTOR SHALL BEAR ALL EXPENSES FOR THE REPAIR OR REPLACEMENT OF UTILITIES OR OTHER PROPERTY DAWAGED IN CONJUNCTION WITH THE EXECUTION OF WORK.

THE CONTRACTOR SHALL BE RESPONSIBLE FOR THE COMPLETE SECURITY OF THE PROJECT SITE WHILE THE JOB IS IN PROGRESS AND UNTIL THE JOB IS COMPLETED AND ACCEPTED BY AT&T MOBILITY.

- THE LATEST EDITION OF THE AMERICAN INSTITUTE OF ARCHITECTS DOCUMENT 20. THE CONTRACTOR SHALL PROVIDE TEMPORARY WATER, POWER AND
 - CONSTRUCTION DOCUMENTS TO ILLUSTRATE THE AS-BUILT
 CONDITION OF THE SITE. THIS SHALL BE DONE AFTER THE SITE
 HAS BEEN AWARDED FINAL INSPECTION BY THE RESPONSIBLE BUILDING AGENCY, ONE SET OF REDLINED DRAWINGS SHALL BE PROVIDED TO THE AT&T MOBILITY CONSTRUCTION MANAGER
 - 22. THE LATEST EDITION OF ALL PERMITTED AND APPROVED PLANS PERTAINING TO THIS PROJECT SHALL BE KEPT IN A PLAN BOX AND SHALL NOT BE USED BY WORKERS. ALL CONSTRUCTION SETS SHALL REFLECT THE SAME INFORMATION. THE CONTRACTOR SHALL ALSO MAINTAIN IN GOOD CONDITION, ONE COMPLETE SET OF PLANS WITH ALL REVISIONS, ADDENDA AND CHANGE ORDERS ON THE PREMISES AT ALL TIMES. THESE ARE TO BE UNDER THE CARE OF THE JOB SUPERINTENDENT.
 - MATERIALS ON A DAILEY BASIS, EXCEPT FOR THAT SPECIFIED AS REMAINING THE PROPERTY OF THE BUILDING OR PROPERTY OWNER AND SHALL EXERCISE STRICT CONTROL OVER JOB CLEANING
 THROUGHOUT CONSTRUCTION, INCLUDING FINAL CLEAN—UP UPON
 COMPLETION OF WORK, ALL AREAS ARE TO BE LEFT IN A BROOM CLEAN CONDITION AT THE END OF EACH DAY AND VACUUM CLEAN CONDITION, FREE FROM PAINT SPOTS, DUST OR SMUDGES OF ANY NATURE AT COMPLETION OF WORK
 - 24. THE GENERAL CONTRACTOR MUST PERFORM WORK DURING PROPERTY OWNER'S PREFERRED HOURS TO AVOID DISRUPTION OF NORMAL ACTIVITY.

 - 26. SEAL ALL PENETRATIONS THROUGH FIRE—RATED AREAS WITH U.L. LISTED OR FIRE MARSHALL APPROVED MATERIALS IF AND WHERE APPLICABLE TO THIS FACILITY AND PROJECT SITE.

 - 28.ELECTRICAL POWER SYSTEM SHALL BE GROUNDED PER NEC
 - 29. ALL NEW OPENINGS IN THE EXTERIOR ENVELOPE OF CONDITIONED SPACES SUCH AS AT WALL AND ROOF PENETRATIONS SHALL BE CAULKED OR SEALED TO LIMIT INFILTRATION OF AIR AND MOISTURE
 - 30.UPON COMPLETION OF CONSTRUCTION, AT&T MOBILITY CONSTRUCTION MANAGER SHALL CONDUCT A WALK-THRU WITH PROPERTY OWNER OR REPRESENTATIVE OF PROPERTY OWNER.
 - 31. THE CONTRACTOR SHALL BE RESPONSIBLE FOR MAINTAINING ALL SYSTEM EQUIPMENT IN A CLEAN WORKING ORDER UNTIL ACCEPTANCE OF THE PROJECT BY AT&T MOBILITY.
 - 32.INSTALL ALL EQUIPMENT AND MATERIALS PER THE LATEST EDITION OF THE MANUFACTURER'S INSTALLATION SPECIFICATIONS LINESS. SPECIFICALLY OTHERWISE INDICATED, OR WHERE LOCAL CODES OR

ROOFING & WATERPROOFING NOTES

- 1. CONTRACTOR SHALL CONTACT BUILDING OWNER TO DETERMINE IF ROOF IS UNDER WARRANTY, CONTRACTOR SHALL GUARANTEE THAT ANY AND ALL NEW ROOFING WORK MEETS THE SPECIFICATION OF ANY EXISTING ROOFING WARRANTIES SUCH THAT THE WARRANTY IS NOT MADE INVALID AS A RESULT OF THIS WORK, IF IT IS DETERMINED THAT THE ARCHITECT'S DETAILING IS INADEQUATE OR IMPROPER OR IF ANY OTHER DISCREPANCY IS FOUND, THE CONTRACTOR SHALL IMMEDIATELY NOTIFY THE ARCHITECT AND THE AT&T MOBILITY PROJECT MANAGER IN WRITING. ULTIMATELY, THE CONTRACTOR SHALL BE RESPONSIBLE FOR COMPLYING WITH THE ORIGINAL ROOF MANUFACTIRER'S SPECIFICATIONS
- 2. CONTRACTOR SHALL USE METHODS AND MATERIALS SIMILIAR AND COMPATIBLE WITH EXISTING MATERIALS & CONDITIONS FOR ROOF PATCHING, NEW PENETRATIONS, ETC.
- 3. THE CONTRACTOR SHALL PROPERLY SEAL ALL NEW ROOF & BUILDING ENVELOPE PENETRATIONS SUCH THAT THE INTEGRITY OF THE ORIGINAL BUILDING ASSEMBLY AND ALL APPLICABLE WARRANTIES ARE MAINTAINED
- 4.IF IT DEEMED NECESSARY TO REMOVE EXISTING FINISHES AND/OR MATERIALS, THE CONTRACTOR SHALL BE RESPONSIBLE FOR RECONSTRUCTING FINISHES AND MATERIALS TO LIKE—NEW CONDITION. CONTRACTOR SHALL MAINTAIN THE ORIGINAL COLORS, TEXTURES & FINISHES UNLESS SPECIFICALLY NOTED TO THE CONTRARY OR APPROVED BY THE AT&T MOBILITY CONSTRUCTION MANAGER IN
- 5. AT THE AT&T MOBILITY CONSTRUCTION MANAGER'S DIRECTION THE CONTRACTOR WARMANGER S DIRECTION,
 THE CONTRACTOR SHALL PROVIDE ROOFTOP WALKPADS TO ALL NEW
 EQUIPMENT INCLUDING ANTENNAS AND BTS UNITS AND ALONG COAX
 CABLE ROUTING. ON CONVENTIONAL ROOFING, THE WALK PADS SHALL BE "DUCK BOARDS" AS MANUFACTURED BY APC OR EQUAL. ON SPECIAL ROOFING SYSTEMS SUCH AS SINGLE MEMBRANE ROOFS WILL REQUIRE A SPECIFIC PRODUCT AS NOTED ON PLANS OR AS REQUIRED BY NOTES 1 & 2 ABOVE.

PENETRATION AT FIRE RATED ASSEMBLIES

- 1 AT THE AT&T MORILITY PROJECT MANAGER'S DIRECTION THE CONTRACTOR SHALL PROVIDE "HILTI" HIGH PERFORMANCE FIRESTOP SYSTEM #FS601 AT ALL FIRE RATED PENETRATIONS INSTALLED PER MANUFACTURER'S LATEST INSTALLATION SPECIFICATIONS.
- 2 ALL PENETRATIONS THROUGH FIRE RATED ASSEMBLIES SHALL BE CONSTRUCTED SO AS TO MAINTAIN AN EQUAL OR GREATER FIRE RATING

PAINTING NOTES & SPECIFICATIONS

- GENERAL
- ALL PAINT PRODUCT LINES SHALL BE SHERWIN WILLIAMS UNLESS SPECIFICALLY NOTED OTHERWISE
- CONTRACTOR SHALL PREPARE ALL SURFACES AND APPLY ALL FINISHES PER LATEST EDITION OF MANUFACTURER'S SPECIFICATIONS.
- COMPLY WITH MANUFACTURER'S WRITTEN INSTRUCTIONS REGARDING SUFFICIENT DRING TIME SETWEEN COATS WITH PROVISIONS AS RECOMMENDED BY MANUFACTURER FOR EXISTING WEATHER CONDITIONS.
- FINISH COLOR AND TEXTURE OF ALL PAINTED SURFACES SHAL MATCH EXISTING ADJACENT SURFACES UNLESS OTHERWISE NOTED.
- ALL PAINT MATERIAL DATA SHEETS SHALL BE PROVIDED TO THE
- PREPARE PREVIOUSLY PAINTED SURFACE BY LIGHT SANDING WITH 400 GRIT SANDPAPER AND NON-HYDROCARBON WASH. PREPARE GALVANIZED SURFACES BY ACID ETCH OR SOLVENT CLEANING IN ACCORDANCE WITH SSPC-SP1.
- FURNISH DROP CLOTHES, SHIELDS, MASKING AND PROTECTIVE METHODS TO PREVENT SPRAY OR DROPPINGS FROM DAMAGING ADJACENT SURFACES AND
- APPLY PAINT BY AIRLESS SPRAY, SANDING LIGHTLY BETWEEN EACH SUCCEEDING ENAMEL COAT ON FLAT SURFACES. APPLY MATERIAL TO ACHIEVE A COATING NO THINNER THAN THE DRY FILM THICKNESS INDICATED.
- APPLY BLOCK FILTER TO CONCRETE BLOCK CONSTRUCTION AT A RATE TO ENSURE COMPLETE COVERAGE WITH PORES COMPLETELY FILLED
- 10. CONTRACTOR SHALL CORRECT RUNS, SAGS, MISSES AND OTHER DEFECTS INCLUDING INADEQUATE COVERAGE AS DIRECTED BY THE ATAT MOBILITY CONSTRUCTION MANAGER. REPAINT AS NECESSARY TO ACHIEVE SURFACES WHICH ARE SMOOTH, EVENLY COATED WITH UNIFORM SHEEN AND FREE FROM BLEMISHES.
- R PAINTING SCOPE
- PAINT THE FOLLOWING MATERIALS AND SYSTEMS CHECKED BELOW WITH THE COATING SYSTEM INDICATED

PAINTING	SCOPE			
SURFACE TO BE PAINTED	COATING SYSTEM	PAINT	DO NOT PAINT	N/A
BTS UNIT				
ALL EQUIPMENT & CABINETS OTHER THAN THE BTS UNIT				
ANTENNA COVERS, TILT BRACKETS, MOUNTING BRACKETS AND ASSOCIATED HARDWARE, CABLE AND CABLE COVERS EXPOSED TO VIEW, EXPOSED CONDUIT AND HANGERS, ETC.				
FLASHING UNITS, METAL TRIM AND OTHER METAL SURFACES				
STUCCO, CONCRETE, CONCRETE BLOCK AND CEMENTIOUS TYPE FINISH SYSTEMS.				
PLYWOOD, LUMBER AND WOOD TRIM INCLUDING THE BACK SIDE OF ALL SCREENWALLS				
DRYWALL				
CONCRETE POLES				
METAL POLES AND METAL POLE STAND-OFF				

- C COATING SYSTEM SPECIFICATIONS
- DTM ACRYLIC COATING (SERIES B66) BY SHERWIN WILLIAMS CO. 1MIL DFT PER COAT APPLIED IN TWO COATS OVER DTM BONDING PRIMER (B66A50).
- 100% ACRYLIC, LATEX COATING EQUIVALENT TO A-100 (SERIES A-82) BY SHERWIN WILLIAMS CO. 1 MIL DFT PER COAT APPLIED IN TWO COATS OVER SPECIFIED PRIMER

PAINT & PRIMER

ANTENNAS

PRIMER - KEM AQUA F61-W525 TOPCOAT - COROTHANE II B65W200/B60V22

BTS CABINET

PRIMER - KEM AQUA E61-W525 TOPCOAT - COROTHANE II B65W200/B60V22

COAXIAL JUMPER CABLES PRIMER — AS REQUIRED FOR ADHESION. APPLY6 ONE COAT OF KEM AQUA WATER REDUCIBLE PRIMER E61W25 REDUCED 25% TOPCOAT - 2 COATS COROTHANE II POLYURETHANE B65W200/B60V2

RAW STEEL
PRIMER - KEM BOND HS B50WZ4, DMT ACRYLIC PRIMER

TOPCOAT - 2 COATS COROTHANE II POLYURETHANE B65W200/B60V2

GALVANIZED METAL

ACID ETCH WITH COMMERCIAL ETCH OR VINEGAR PRIMER COAT AND FINISH COAT (GALVITE HIGH SOLIDS OR DTM PRIMER/FINISH)

STAINLESS STEEL

PRIMER - OTM WASH PRIMER, B71Y1 TOPCOAT - 2 COATS COROTHANE II POLYURETHANE B65W200/B60V2

TOUCH UP ANY RUST OR UN-PRIMED STEEL WITH KEM BOND HS. SSOWZ4

ALUMINUM & COPPER

PRIMER - DTM WASH PRIMER. B71Y1 TOPCOAT - 2 COATS COROTHANE II POLYURETHANE B65W200/B60V2

CONCRETE MASONRY

PRIMER - PRO MAR EXTERIOR BLOCK FILLER
TOPCOAT - 2 COATS A-100 LATEX HOUSE & TRIM, SHEEN TO MATCH

CONCRETE STUCCO(EXISTING)

2 COATS A-100 LATEX HOUSE & TRIM, SHEEN TO MATCH

TOPCOAT - SUPERPAINT A-80 SERIES A-89 SATIN A-84 GLOSS

PRIMER - A-100 EXTERIOR ALKYD WOOGD PRIMER Y-24W20 TOPCOAT - 2 COATS A-100 LATEX HOUSE & TRIM SHEEN TO MATCH ADJACENT SURFACES

PRIMER - A-100 EXTERIOR ALKYD WOOD PRIMER Y-24W20 TWO COATS SHOP APPLIED PER GLU-LAM MANUFACTURER'S SPECIFICATIONS TOPCOAT - SUPERPAINT A-80 SERIES A-89 SATIN A-84 GLOSS TWO COATS SHOP OR FIELD APPLIED AT CONTRACTOR'S OPTION

FIELD CUTS/DAMAGE(PRIOR TO PRIME & PAINT) FIRST & SECOND COAT — CUPRINOL CLEAR WOOD PRESERVATIVE #158-0356 ALL PENETRATIONS INTO FINISHED CLU-LAMS SHALL BE CALLIKED WITH "SIKAFLEX" SEALANT

STEEL THAT HAS BEEN WELDED, CUT OR SCRATCHED IN THE FIELD

STRUCTURAL SPECIFICATIONS

PRECEDENCE: UNLESS OTHERWISE SHOWN OR SPECIFIED, THE FOLLOWING GENERAL NOTES SHALL APPLY, INFORMATION ON THESE DRAWINGS SHALL HAVE THE FOLLOWING PRECEDENCE

- ALL DIMENSIONS TO TAKE PRECEDENCE OVER SCALE SHOWN ON
- B. NOTES AND DETAILS ON DRAWINGS SHALL TAKE PRECEDENCE OVER GENERAL NOTES AND TYPICAL DETAILS.
- C. MATERIAL NOTES AND SPECIFICATIONS ON THE DRAWINGS SHALL
- TAKE PRECEDENCE OVER THE SPECIFICATIONS . OTHER TRADES: SEE THE ARCHITECTURAL DRAWINGS FOR ALL
- . GENERAL DETAILS AND NOTES ON THESE SHEETS SHALL APPLY UNLESS SPECIFICALLY SHOWN OR NOTED OTHERWISE. CONSTRUCTION DETAILS NOT FULLY SHOWN OR NOTED SHALL BE SIMILAR TO DETAILS SHOWN FOR SIMILAR CONDITIONS.
- SHORING: IT SHALL BE THE RESPONSIBILITY OF THE CONTRACTOR TO INSTALL ALL TEMPORARY BRACING AND SHORING TO INSURE THE SAFETY OF THE WORK UNTIL IT IS IN IT'S COMPLETED FORM THIS INCLUDES UNDERPINNING EXISTING FOOTINGS WHERE
- SAFETY: THESE STRUCTURAL DRAWINGS REPRESENT THE FINISHED STRUCTURE. UNLESS OTHERWISE INDICATED, THEY DO NOT INDICATE THE METHOD OF CONSTRUCTION.
- WATERPROOFING: WATERPROOFING AND DRAINAGE, DETAILS AND SPECIFICATIONS ALTHOUGH SOMETIMES SHOWN ON STRUCTURAL DRAWING ARE OF GENERAL INFORMATION PURPOSES ONLY WATERPROOFING AND DRAINAGE ARE SOLELY THE DESIGN RESPONSIBILITY OF THE ARCHITECT.
- B STEEL

A. GENERAL

- ALL STRUCTURAL STEEL SECTIONS AND WELDED PLATE MEMBERS SHALL CONFORM TO ASTM A-36 AND BE FABRICATED IN ACCORDANCE WITH THE SPECIFICATIONS OF THE AISC.
- ALL BOLTS SHALL CONFORM TO ASTM A-307 UNLESS OTHERWISE NOTED ON PLANS. HIGH STRENGTH BOLTS SHALL CONFORM TO ASTM A-325
- 3. STEEL PIPE COLUMNS SHALL BE GRADE "B" CONFORMING TO ASTM
- 4. STEEL TUBING SHALL BE GRADE "B" CONFORMING TO ASTM A500.
- ALL WELDING SHALL BE DONE BY THE SHIELDED ARC METHOD. ALL WELDERS SHALL BE PROPERLY QUALIFIED AND BE PRE—APPROVED.
 SURPLUS METAL SHALL BE DRESSED OFF TO SMOOTH, EVEN
 SURFACES WHERE WELDS ARE NOT EXPOSED TO VIEW. ALL WELDING SHALL COMPLY WITH THE LATEST A.W.S. SPECIFICATIONS
- 5. THE FOLLOWING WELDING EQUIPMENT MUST BE USED: B. ROD OVENS. C. GRINDERS.
- 7. NO BUZZ BOXES SHALL BE USED.
- 8. ALL STRUCTURAL STEEL SHALL MILL CERTIFICATION, MILL CERTIFICATION SHALL BE KEPT ON THE JOB SITE FOR EXAMINATION BY THE DESIGN ENGINEER AND THE CITY INSPECTOR
- ALL HIGH STRENGTH BOLTS SHALL HAVE MILL CERTIFICATION. MILL CERTIFICATION SHALL BE KEPT ON THE JOB SITE FOR EXAMINATION BY THE INSPECTOR.
- STEEL THAT HAD BEEN WELDED, CUT OR SCRATCHED IN THE FIELD SHALL BE TOUCHED UP WITH COLD GALVANIZING PAINT
- WELDING INDICATED IN THESE DRAWINGS IS DESIGNED FOR ONE HALF OF ALLOWABLE CODE STRESSES UNLESS SPECIFICALL NOTED "FULL STRESS" AT END OF WELD SYMBOL.
- CONCRETE
- STRENGTH: CONCRETE FOR THE PROJECT SHALL HAVE THE FOLLOWING ULTIMATE COMPRESSIVE STRENGTH AT AGE OF 28 DAYS:

LOCATION STRENGTH WT. SLUMP ADMIXTURE

- A. SLAB&FOOTING 3000psi 150pcf 4"
- INSPECTION: CONCRETE WITH SPECIFIED STRENGTH GREATER THAN 2500psi SHALL BE CONTINUOUSLY INSPECTED DURING PLACEMENT BY A DEPUTY INSPECTOR EMPLOYED BY A TESTING LABORATORY APPROVED BY THE BUILDING DEPT
- REBAR GRADES: REINFORCING STEEL SHALL BE CLEAN PREFORMED BARS CONFORMING TO ASTM A615 AS FOLLOWS:

& SMALLER BARS.....GRADE 40 #5 & LARGER BARS......GRADE 60 ALL BARS AT CAISSON FOOTING...GRADE 60

- CEMENT: FOUNDATIONS & SLABS: TYPE V, LOW ALKALI, CONFORMING TO ASTM C-150 PIER/CAISSON FOOTINGS: TYPE V, LOW ALKALI, CONFORMING
- AGGREGATE: USED IN THE CONCRETE SHALL CONFORM TO ASTM C-33. USE ONLY AGGREGATES KNOWN NOT TO CAUSE EXCESSIVE SHRINKAGE. THE MAXIMUM SIZE AGGREGATE IN CONCRETE WORK SHALL BE THE FOLLOWING:
- A. FOUNDATIONS & SLABS 9" OR LESS: 3/4" GRAVEL B PIER/CAISSON FOOTING: 1" GRAVEL
- WATER: SHALL BE CLEAN AND FREE FROM DELETERIOUS AMOUNT OF ACIDS, ALKALIS, ORGANIC MATERIALS AND SHALL BE SUITABLE FOR HUMAN CONSUMPTION.

- 7. MIXING: PREPARATION OF CONCRETE SHALL CONFORM TO ASTM
- MINING: FREFARATION OF CONCRETE SHALL CLAPSE BETWEEN CONCRETE BATCHING AND CONCRETE PLACEMENT UNLESS APPROVED BY A TESTING AGENCY. SEGREGATION OF AGGREGATES: CONCRETE SHALL NOT BE FLOPPED THROUGH REINFORCING STEEL (AS IN WALLS, COLUMNS, CAISSON,
- AND DROP CAPITALS) SO AS TO CAUSE SEGREATION OF AGGREGATES USE HOPPERS, CHUTES, TRUNKS OR PUMP HOSE SO THAT THE FREE UNCONFINED FALL OF CONCRETE SHALL NOT EXCEED 5 FT. 9. SPLICES OF REINFORCING STEEL SHALL BE LAPPED A MINIMUM OF 3 DIAMETERS AND SECURELY WIRED TOGETHER. SPLICES OF ADJACENT REINFORCING BARS SHALL BE STAGGERED WHEREVER POSSIBLE.
- 10 REAR CLEARANCE: MINIMUM COVERAGE FOR JOISTS BEAMS GIRDERS AND COLUMNS SHALL BE TO FACE OF STIRRUPS OR TIES. UNLESS OTHERWISE NOTED, CONCRETE COVERAGE FOR REINFORCING BARS T FACE OF BAR SHALL BE AS FOLLOWS:

A CONCRETE IN CONTACT WITH EARTH LINEORMED B. CONCRETE IN CONTACT WITH EARTH, FORMED WALL, EXTERIOR FACE WALL, INTERIOR FACE STRUCTURAL SLABS 3/4"

JOISTS BEAMS, GIRDERS & COLUMNS

11. PENETRATIONS: NO SLEEVES OR CHASES SHALL BE PLACED IN BEAMS, SLABS, WALLS AND COLUMNS, EXCEPT THOSE SHOWN ON THE PLANS. CONTRACTOR SHALL OBTAIN PRIOR APPROVAL FOR INSTALLATIONS OF ANY ADDITIONAL SLEEVES OR CHASES. ALL PLUMBING, ELECTRICAL AND MECHANICAL OPENINGS SHALL BE SLEEVES, CORING IS NOT ALLOWED UNLESS PRIOR APPROVAL IS OBTAINED FROM THE STRUCTURAL ENGINEER

- 12. EMBEDDED ITEMS: CONDUIT PLACED IN A CONCRETE SLAB SHALL NOT HAVE AN OUTSIDE DIAMETER GREATER THAN 1/4 THE THICKNESS OF THE SLAB. CONDUIT SHALL NOT BE EMBBEDED IN A SLAB THAT IS LESS THAN 3-1/2" THICK, UNLESS SLAB IS LOCALLY THICKENED. MINIMUM CLEAR DISTANCE BETWEEN COUNDUITS SHALL BE SIX INCHES
- 13. ANCHORING: ALL ANCHOR BOLTS, REINFORCING STEEL, DOWELS, INSERTS, ETC., SHALL BE WELL SECURED IN POSITION PRIOR TO PLACING CONCRETE. NO REPOSITIONING DURING CONCRETE POUR 14. CURING: SLABS SHALL BE SPRAYED WITH A CURING COMPOUND
- IMMEDIATELY AFTER FINISHING. CURING COMPOUNDS USED ON CONCRETE WHERE TILE OR FLOOR COVERING IS TO BE BONDED TO THE CONCRETE SURFACE SHALL BE APPROVED BY THE TILE OR FLOOR COVERING MANUFACTURER. KEEP SLAB WET FOR 7 D.
- 15. CONSOLIDATION: ALL CONCRETE SHALL BE VIBRATED AS IT IS BEING PLACED WITH ELECTRICALLY OPERATED VIBRATING EQUIPMENT.
- D TIMBER
- ALL FRAMING LUMBER FOR 4X AND LARGER BEAMS SHALL BE NO. GRADE DOUGLAS FIR., \$45, UNLESS NOTED OTHERWISE ON THE DRAWINGS.
- 2. ALL FRAMING LUMBER FOR 2X RAFTERS AND JOISTS SHALL BE NO.2 GRADE DOUGLAS FIR, S45, UNLESS NOTED OTHERWISE ON DRAWINGS
- 3. STRIPPING BLOCKING BACKING AND OTHER NON-STRUCTURAL LUMBER SHALL BE NO. 2 OR STD & BTR GRADE DOUGLAS FIR, S4S. 2X4 STUD WALLS SHALL BE D.F. STANDARD & BTR.
- 4. ALL BEAMS, JOISTS AND RAFTERS SHALL BE INSTALLED WITH CROWN 5. ROOF PLYWOOD SHALL MATCH EXISTING PLYWOOD SHEATHING WITH A
- SPAN INDEX RATIO 32/16, FDGF NAIL WITH8d AT 6" O.C. UNLESS NOTED OTHERWISE ON PLANS, FGIELD NAIL WITH 8d AT 12" O.C. 6. PLYWOOD SHEETS SHALL BE LAID WITH THE FACE GRAIN
- PERPINDICULAR TO SUPPORTS AND WITH THE EDGES STAGGERED, UNLESS NOTED OTHERWISE ON THE PLANS.
- 7. PLYWOOD SHALL BE GRADE MARKED BY DFPA, TECO, OR PTL AND SHALL CONFORM TO PS 1-83 8. THE MAXIMUM MOISTURE CONTENT OF ALL LUMBER SHALL NOT
- MINIMUM NAILING SHALL COMPLY WITH TABLE 23-1-q OF BUILDING CODE. ALL NAILS SHALL BE COMMON WIRE NAILS.

EXCEED 24% AT THE TIME OF INSTALLATION.

- 10. ALL BOLTS SHALL HAVE STANDARD CUT WASHERS UNDER HEADS AND/OR NUTS WHERE IN CONTACT WITH WOOD.
- 11. LAG BOLTS SHALL BE SCREWED INTO PLACE, NOT DRIVEN, LAG BOLTS SHALL BE INSTALLED IN PRE-DRILLED HOLES WITH A DIAMETER EQUAL TO 75% DIAMETER OF BOLT. 12. CONNECTORS: ALL SHEET METAL FRAMING CONNECTORS SHOWN IN
- THE PLANS SHALL BE STRONG CONNECTORS AS MANUFACTURED BY THE SAMSON COMPANY. SUBSTITUTIONS MAY BE MADE WHEN APPROVED BY THE STRUCTURAL ENGINEER. 13. ALL LUMBER EXPOSED TO WEATHER OR IN CONTACT WITH MASONRY OR CONCRETE SHALL BE WOLMANIZED PRESSURE TREATED LUMBER OR A NATURALLY DECAY RESISTANT LUMBER SUCH AS REDWOOD OF
- 14. ALASKAN YELLOW CEDAR GLUE-LAMINATED BEAMS
- A. LUMBER SPECIES: ALASKAN YELLOW CEDAR (A.C.) CONFORMING TO 20F-V12 B. STRENGTH PROPERTIES:
- FIGURE FROM FIBER BENDING STRESS 2000psi MIN. FO TOP FIBER BENDING STRESS 1000-11
- Fb TOP FIBER BENDING STRESS 1000psi MIN.
 Fc SHEAR STRESS 190psi MIN.
 Fc COMPRESSION STRESS PERPENDICULAR TO GRAIN 560psi MIN. MODULUS FLASTICITY 1400ks; MIN
- CAMBER TO RADIUS OF 1600° U.O.N. D. ALL GLB'S SHALL BE FABRICATED WITH EXTERIOR GLUE.
- F. GLU-LAM MATERIAL SHALL BE IN ACCORDANCE WITH ANSI/AITC A190.1 AND ASTM D3737.



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«MasTec **Network Solutions**

ANITA JEN 12/29/17 0% CDS DATE ANITA JEN 02/22/18 100% CDS DATE ANITA JEN 02/22/18 100% CDS WITH STRUCTURALS DATE 01/09/18 CONSTRUCTION DATE DATE SITE ACQUISITION

> PROJECT NAME MICROWAVE UPGRADE SITE NAME

WILCOX AND COLLEGE FA NUMBER


> 10127031 1314 RED CEDAR CIRCLE FORT COLLINS, COLORADO 80525

DRAWING DATES 12/27/17 90% CD REVIEW (P1-B1) 02/22/18 100% FINAL CDS (P1-B2)

SHEET TITLE

SPECIFICATIONS AND NOTES

(E) AT&T LEASE AREA WITHIN (E) COMPOUND; SEE SHEET A-1.1.

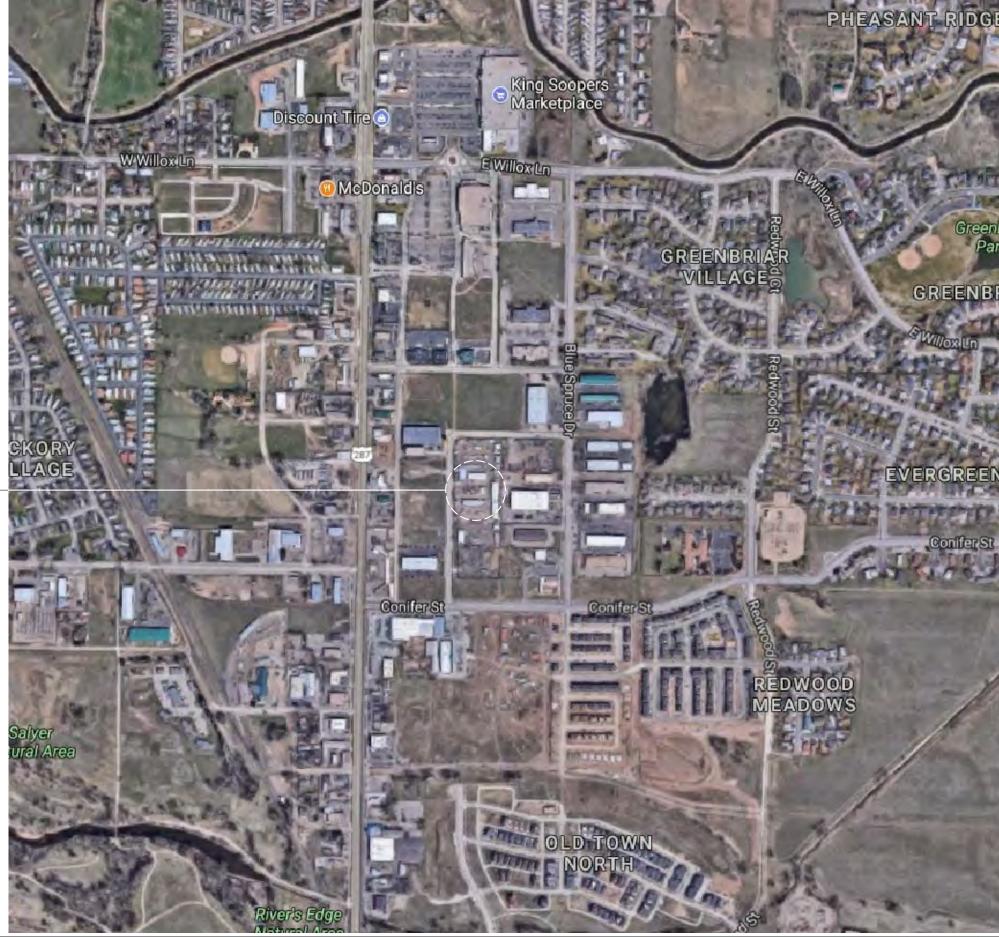



SCALE: 0 75' 150' 300' 1"=300'

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100% CDS	DATE
ANITA JEN	02/22/1
100% CDS WITH STRUCTURALS	DATE
CHRISTINA MICHAUD	01/09/1
CONSTRUCTION	DATE
OUTS ADDITION	DATE
SITE ACQUISITION	DATE

PROJECT NAME

MICROWAVE UPGRADE SITE NAME

WILCOX AND COLLEGE FA NUMBER

10127031 1314 RED CEDAR CIRCLE FORT COLLINS, COLORADO 80525

DRAWING DATES


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SHEET TITLE

OVERALL SITE PLAN

A-0

1 (E) AT&T LEASE AREA WITHIN (E) COMPOUND; SEE SHEET A-1.1.



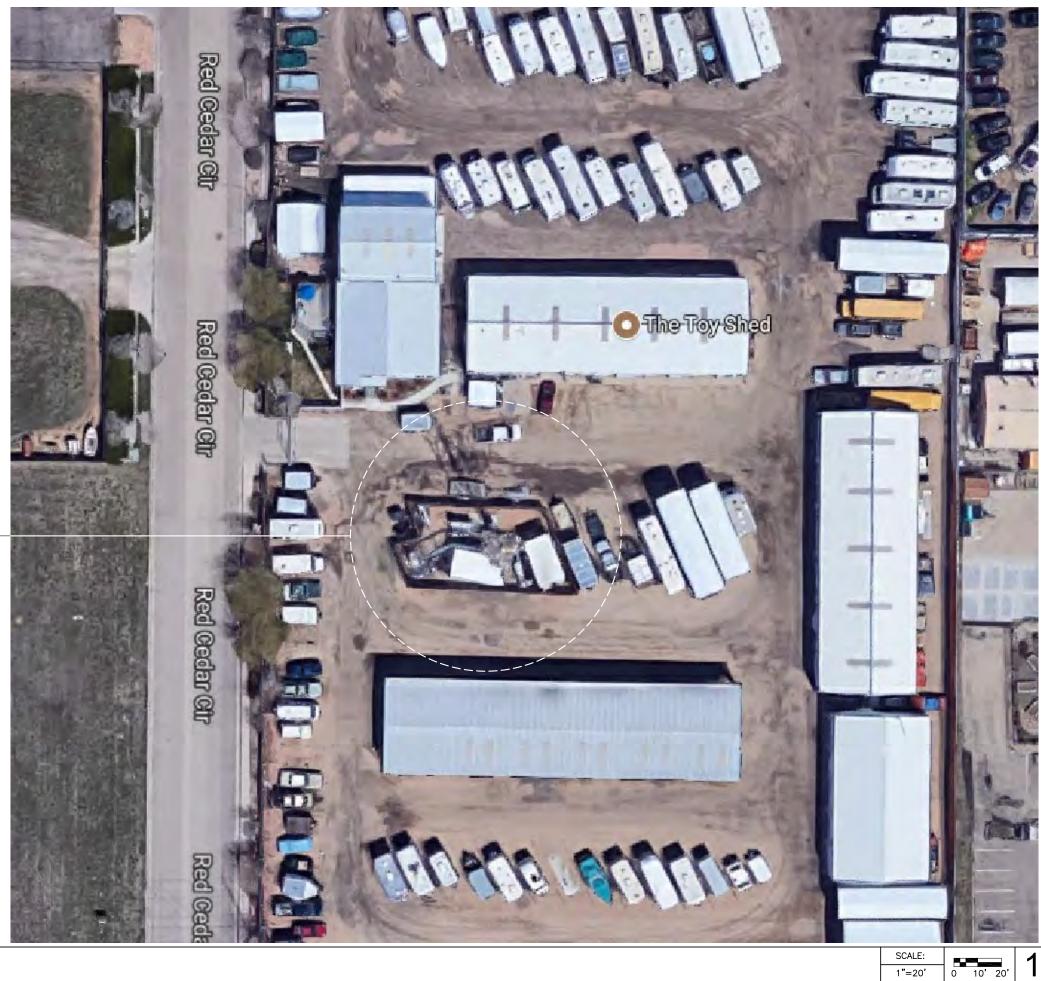


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100% CDS WITH STRUCTURALS	DATE
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CONSTRUCTION	DATE
SITE ACQUISITION	DATE

PROJECT NAME
MICROWAVE UPGRADE

SITE NAME

WILCOX AND COLLEGE FA NUMBER
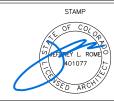
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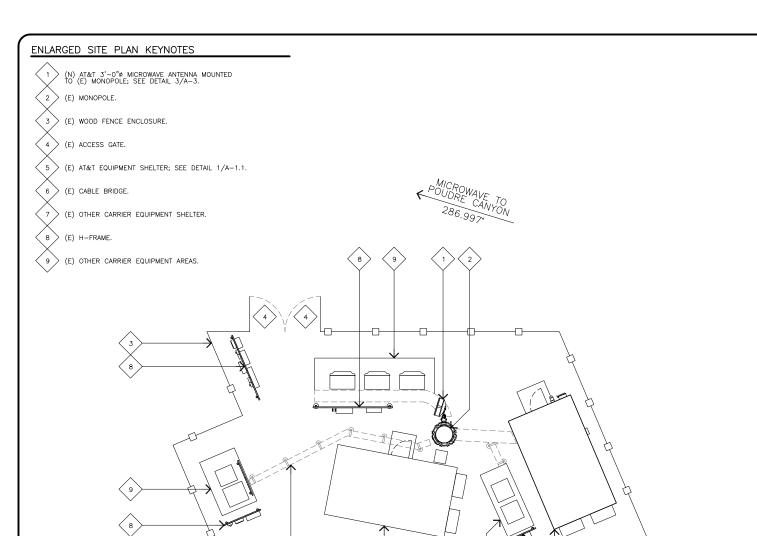
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SHEET TITLE

SITE PLAN

A-1

1"=20'



ENLARGED SITE PLAN GENERAL NOTES

- A. OTHER CARRIER ANTENNAS NOT SHOWN FOR CLARITY
- B. GROUND ALL (N) EQUIPMENT AND COAX PER DETAIL 4/A-3.
- C. OTHER CARRIER ANTENNAS NOT SHOWN FOR CLARITY.
- D. CONTRACTOR TO PROVIDE ALL LABOR TO INSTALL COAX, RETS AND ANTENNAS.
- E. CONTRACTOR TO PROVIDE ALL COAX, CONNECTORS, ANCILLARY EQUIPMENT (INCLUDING WEATHER STRIPPING, GROUND KITS, ETC.).
- F. CONTRACTOR TO COLOR CODE ALL COAX. COLORED BANDS OF TAPE ON COAX IDENTIFY SECTOR, FREQUENCY, TECHNOLOGY, AND TRANSMIT GROUP AS FOLLOWS ON ALL COAX MODIFIED OR INSTALLED ONLY.
- G. WHEN ANTENNA LINES ARE DIPLEXED, THE COLOR CODE OF THE HIGHEST FREQUENCY PREVAILS (I.E. UMTS DIPLEXED WITH TDMA SHOULD HAVE COLOR 4 BANDS).
- H. ALL ANTENNAS AND ANTENNA CABLE SHALL BE FURNISHED BY CONTRACTOR AND INSTALLED BY ANTENNA INSTALLATION CONTRACTOR.
- PRIOR TO PLACEMENT OF ANTENNA POLE MOUNTS, THE CONTRACTOR SHALL VERIFY THAT THE AZIMUTH AND DIMENSIONS SHOWN ON THE PLANS MATCH ACTUAL FIELD CONDITIONS. ALLOWABLE TOLERANCE: HORIZONTAL ALIGNMENT = ± 5 ; VERTICAL ALIGNMENT = ± 1 1.
- J. ANTENNA INSTALLATION CONTRACTOR SHALL PROVIDE ALL CONDUIT, CABLE TRAY, GROUNDS, ETC. FOR COMPLETE INSTALLATION OF ANTENNAS AND CABLES SHOWN AND INTENDED AS REQUIRED FOR A COMPLETE OPERATING SYSTEM IN ACCORDANCE WITH
- K. IN NO CASE SHALL THERE BE ANY MORE THAN TWO (2) 90° TURNS (OR EQUIVALENT) IN ANY CONTINUOUS LENGTH OF CONDUIT BETWEEN PULL BOXES OR SIMILAR FEATURES.

- L. ANTENNA CONDUIT SHALL ONLY INCLUDE FACTORY-MADE LARGE RADIUS SWEEPS AT ALL CHANGES IN DIRECTION. SWEEP RADIUS SHALL BE 18" MINIMUM ABOVE GROUND AND 36" MINIMUM BELOW GROUND.
- M. CONDUIT SHALL BE 3"0 MINIMUM. ALL UNDERGROUND CONDUIT SHALL BE SCHEDULE 40 PVC. ALL EXPOSED CONDUIT ABOVE GRADE LEVEL SHALL BE IMC OR RIGID GALVANIZED. ALL EXPOSED CONDUIT PROTECTED IN A BUILDING OR ON A ROOF SHALL BE EMT OR UV STABILIZED PAINTED SCHEDULE 80 PVC.
- N. IN HIGH TRAFFIC AREAS OR WHERE SUSCEPTIBLE TO DAMAGE CONTRACTOR SHALL PROVIDE FORMED 14 GA. GALVANIZED SHEET METAL COVER OVER COAXIAL CABLE ROUTES. WHERE CABLE IS RUN ON THE WALL, ATTACH UNISTRUT TO WALL AND COVER WITH 14 GA. GALVANIZED FORMED SHEET METAL COVER OR MATERIAL AS DIRECTED BY
- O. VERIFY ROUTE AND LENGTH OF CABLE PRIOR TO CUTTING. ADJUST INDICATED ROUTE AS REQUIRED TO CLEAR (E) EQUIPMENT AT FACILITIES.
- P. MAXIMUM LENGTH OF 7/8" COAX CABLE SHALL BE 140'-0". MAXIMUM LENGTH OF 1-1/4" COAX CABLE SHALL BE 190'-0". MAXIMUM LENGTH OF 1-5/8" COAX CABLE SHALL BE 235'-0"
- Q. VERIFY MODEL NUMBERS OF ANTENNAS WITH CONTRACTOR SERVICES.
- R. THE CONTRACTOR SHALL PROVIDE TESTING OF ANTENNAS AND SHALL PROVIDE DOCUMENTATION TO THE CONTRACTOR PROJECT MANAGER.
- S. GENERAL CONTRACTOR TO VERIFY ALL TORQUE TOLERANCES PER THE MANUFACTURERS SPECIFICATIONS AND RECOMMENDATIONS.



EQUIPMENT PLAN KEYNOTES

(E) AT&T EQUIPMENT SHELTER. (E) AT&T EXTERIOR MOUNTED HVAC UNITS.

(E) AT&T CABLE ENTRY PORT.

(E) AT&T GSM EQUIPMENT CABINET.

5 > (E) AT&T UMTS EQUIPMENT CABINET.

(E) AT&T TELCO BACKBOARD.

(E) AT&T DC POWER PLANT.

 \langle 8 \rangle (E) AT&T DATA RACK.


(E) AT&T ELECTRICAL PANEL.

10 > (E) AT&T BATTERY RACK.

(N) AT&T MICROWAVE RADIO MOUNTED IN (E) DATA RACK.

(N) (2) EW-90 WAVEGUIDE CABLES.

(N) AT&T DC CABLE FROM (E) 24VDC POWER CABINET TO (N) -48VDC CONVERTER, IF REQUIRED.

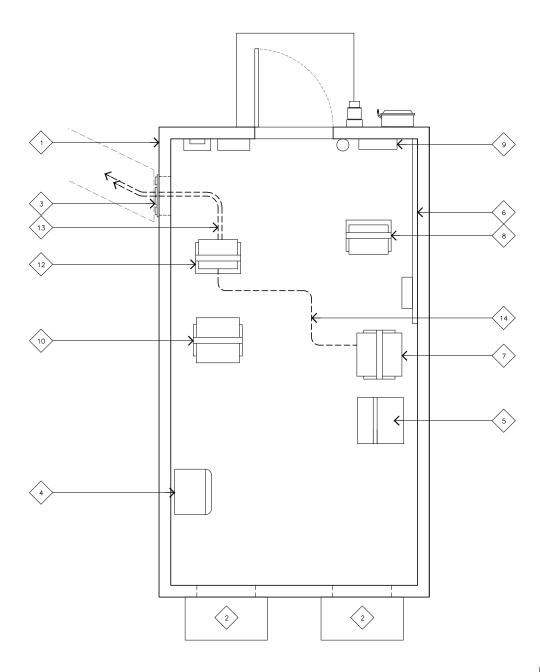



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DATE
02/22/18
DATE
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DATE
01/09/18
DATE
DATE

PROJECT NAME

MICROWAVE UPGRADE

SITE NAME WILCOX AND COLLEGE

FA NUMBER

10127031 1314 RED CEDAR CIRCLE FORT COLLINS, COLORADO 80525

DRAWING DATES

12/27/17 90% CD REVIEW (P1-B1) 02/22/18 100% FINAL CDS (P1-B2)

SHEET TITLE

ENLARGED SITE AND EQUIPMENT PLAN

A-1.1

ENLARGED SITE PLAN


SCALE: 1/8"=1'-0"



EQUIPMENT PLAN





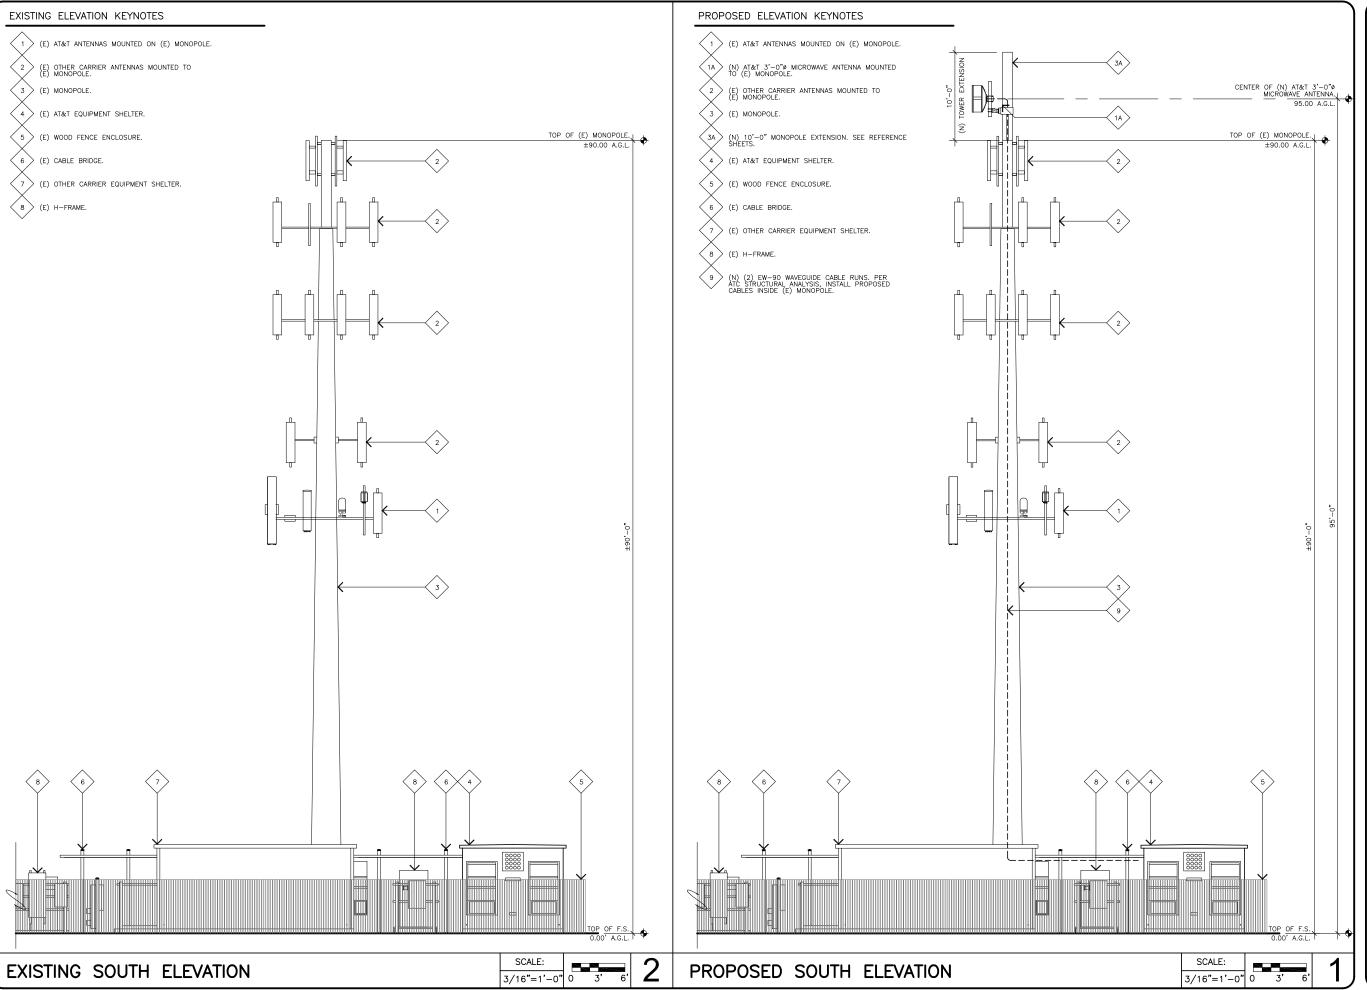



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MasTec Network Solutions

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CONSTRUCTION	DATE
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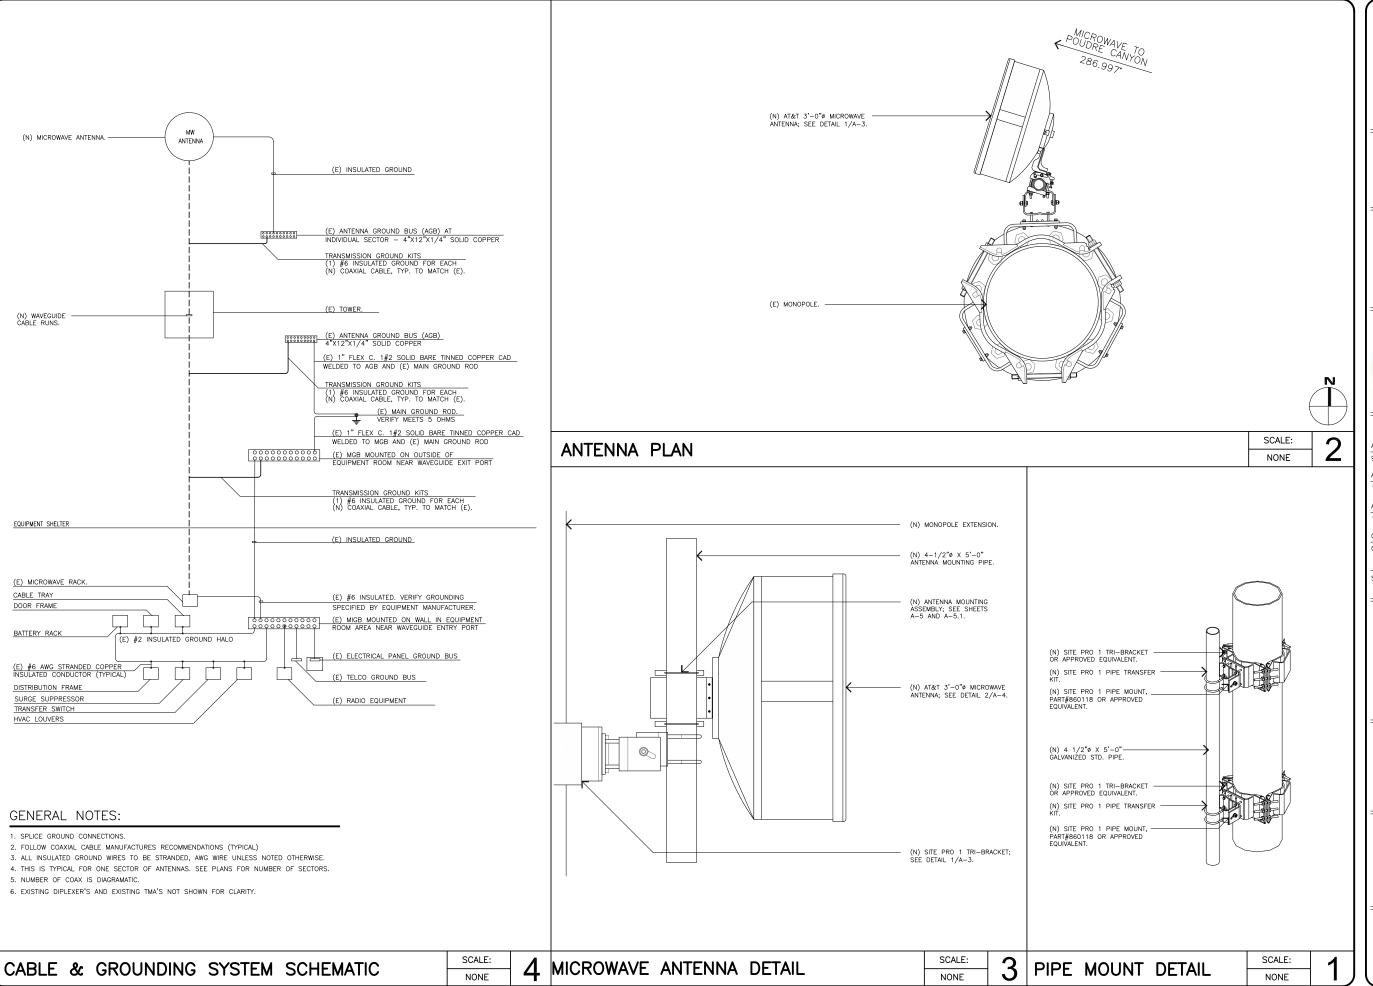
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SHEET TITLE

EXISTING & PROPOSED ELEVATIONS

A-2

JRA JOB NUMBER: 172364



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12/27/17 90% CD REVIEW (P1-B1) 02/22/18 100% FINAL CDS (P1-B2)

SHEET TITLE

ANTENNA DETAILS

Product Specifications









VHLPX3-11VV

1.0 m | 3 ft ValuLine® High Performance Low Profile Antenna

General Specifications

Antenna Type VHLPX - ValuLine® High Performance Low Profile Antenna Diameter, nominal 1.0 m | 3 ft

Mechanical Specifications

Fine Azimuth Adjustment ±15° ±15° Fine Elevation Adjustment Mounting Pipe Diameter 115 mm | 4.5 in 24 kg | 53 lb Net Weight Side Struts, Included Side Struts, Optional 1 inboard Wind Velocity Operational 200 km/h | 124 mph Wind Velocity Survival Rating 250 km/h | 155 mph

Wind Forces At Wind Velocity Survival Rating

Angle a for MT Max Axial Force (FA) 2979 N | 670 lbf 936 N | 210 lbf Side Force (FS) Twisting Moment (MT) 1184 N•m Weight with 1/2 in (12 mm) Radial Ice 46 kg | 101 lb Zcg with 1/2 in (12 mm) Radial Ice 220 mm | 9 in Zcg without Ice 324 mm | 13 in

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EW90

EW90, HELIAX® Standard Elliptical Waveguide



CHARACTERISTICS

Construction Materials

Jacket Material Conductor Material Corrugated copper Jacket Color Black

Dimensions

Cable Volume 334.0 L/km | 3.6 ft3/kft Cable Weight 0.48 kg/m | 0.32 lb/ft 33.50 mm | 1.32 in Diameter Over Jacket (E Plane) Diameter Over Jacket (H Plane) 20.30 mm | 0.80 in

Environmental Specifications

Installation Temperature -40 °C to +60 °C (-40 °F to +140 °F) Operating Temperature -55 °C to +85 °C (-67 °F to +185 °F) Storage Temperature -70 °C to +85 °C (-94 °F to +185 °F)

General Specifications

HELIAX®

Mechanical Specifications

Maximum Twist 6.00 °/m | 2.00 °/ft Minimum Bend Radius, Multiple Bends (E Plane) 180.00 mm | 7.00 in Minimum Bend Radius, Multiple Bends (H Plane) 480.00 mm | 19.00 in Minimum Bend Radius, Single Bend (E Plane) 150.00 mm | 6.00 in Minimum Bend Radius, Single Bend (H Plane) 330.00 mm | 13.00 in

Standard Conditions

Attenuation, Ambient Temperature 24 °C | 75 °F Average Power, Ambient Temperature 40 °C | 104 °F Average Power, Temperature Rise 42 °C | 76 °F

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12/29/17
DATE
02/22/18
DATE
02/22/18
DATE
01/09/18
DATE
DATE

MICROWAVE UPGRADE

SITE NAME

WILCOX AND COLLEGE FA NUMBER

10127031

1314 RED CEDAR CIRCLE FORT COLLINS, COLORADO 80525

DRAWING DATES

12/27/17 90% CD REVIEW (P1-B1)

SHEET TITLE

SPECIFICATIONS

SCALE:

Installation Instructions


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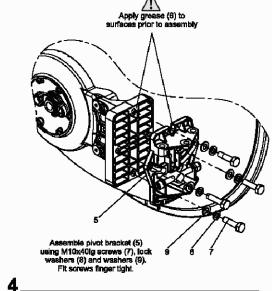
Valuline™ Antenna Mount


Bulletin 7618088 page 2 of 7 Version 04 Status RE Rev E

Model Version 01 Status RE Ray B


Note: Left offset shown



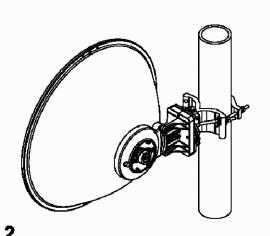

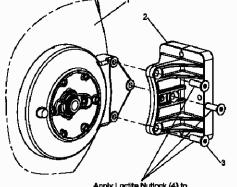

Apply Loctite Nutlock (4) to threads of M10 cs/k screws (3) prior to assembly of mount bracket (2). Tighten to torque of 38Nm ± 5%

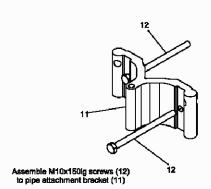

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Installation Instructions

Bulletin 7618088 page 3 of 7

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Network Solutions

ANITA JEN 12/29/17 DATE ANITA JEN 02/22/18 DATE 100% CDS ANITA JEN 02/22/18 100% CDS WITH STRUCTURALS DATE 01/09/18 CONSTRUCTION DATE DATE SITE ACQUISITION

> PROJECT NAME MICROWAVE UPGRADE

SITE NAME WILCOX AND COLLEGE

FA NUMBER 10127031

1314 RED CEDAR CIRCLE FORT COLLINS, COLORADO 80525

DRAWING DATES

12/27/17 90% CD REVIEW (P1-B1)

SHEET TITLE


ANTENNA MOUNTING DETAILS


A-5

Valuline™ Antenna Mount

Model Version 01 Status RE Rev B

COMMSCOPE°

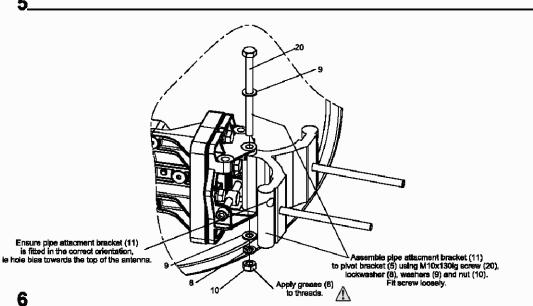

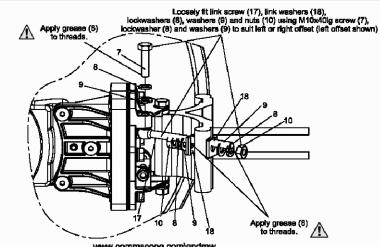

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SCALE:

ANTENNA MOUNTING DETAILS


Installation Instructions

COMMSCOPE°

Valuline™ Antenna Mount

Bulletin 7618088 page 4 of 7

Pole to be structural engineer approved rigid structural support

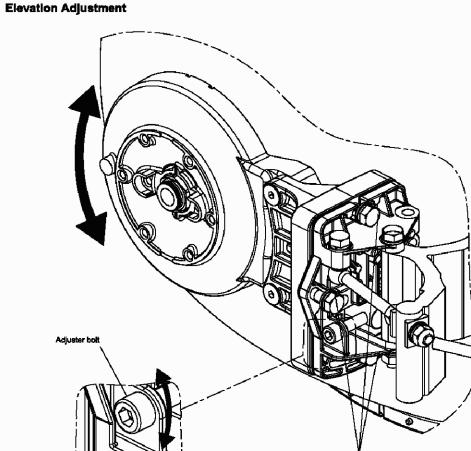

Installation Instructions

Valuline™ Antenna Mount

-Pole to be structural engineer approved rigid structural support

mount to pole.

ensure clamp bolts are seated correctly.

7a

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50-60mm pole application

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Ensure 4 M10 screws are finger tight. Adjust elevation by rotating adjuster bolt. On completion tighten 4 screws to

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APPROVALS	
ANITA JEN	12/29/17
90% CDS	DATE
ANITA JEN	02/22/18
100% CDS	DATE
ANITA JEN	02/22/18
100% CDS WITH STRUCTURALS	DATE
CHRISTINA MICHAUD	01/09/18
CONSTRUCTION	DATE
SITE ACQUISITION	DATE

PROJECT NAME MICROWAVE UPGRADE

SITE NAME

WILCOX AND COLLEGE

FA NUMBER 10127031

1314 RED CEDAR CIRCLE FORT COLLINS, COLORADO 80525

DRAWING DATES

12/27/17 90% CD REVIEW (P1-B1) 02/22/18 100% FINAL CDS (P1-B2)

SHEET TITLE

ANTENNA MOUNTING DETAILS

A-5.1

SCALE:

Installation Instructions

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Valuline™ Antenna Mount

Bulletin 7618088 page 6 of 7

Valuline™ Antenna Mount

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> PROJECT NAME MICROWAVE UPGRADE

> > SITE NAME

WILCOX AND COLLEGE FA NUMBER 10127031

1314 RED CEDAR CIRCLE FORT COLLINS, COLORADO 80525

DRAWING DATES

12/27/17 90% CD REVIEW (P1-B1)

SHEET TITLE

ANTENNA MOUNTING DETAILS

A-5.2

Installation Instructions

-Pole to be structural engineer approved rigid structural support




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Right offset application

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Azimuth adjustment

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SCALE:

ANTENNA MOUNTING DETAILS

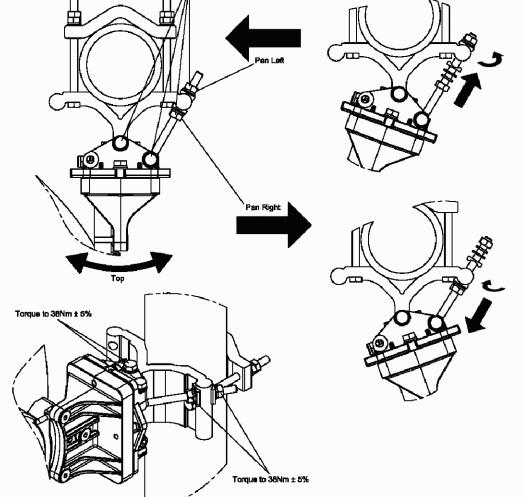

ATC TOWER SERVICES, LLC 3500 REGENCY PARKWAY SUITE 100 CARY, NC 27518 PHONE: (919) 468-0112

302435 - JOSH AMES, COLORADO

90 FT MONOPOLE W/ PROPOSED 10 FT EXTENSION

DESCRIPTION	SIGNATURE	DATE
CONTRACTOR NAME		
CONTRACTOR REPRESENTATIVE (PRINT NAME)		
CONTRACTOR REPRESENTATIVE (SIGNATURE)		
REDEVELOPMENT P.M. (PRINT NAME)		
REDEVE OPMENT P.M. (SIGNATURE)		

PROJECT SUMMARY	PROJECT DESCRIPTION	SHEET	SHEET TITLE	REV
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ATC PROJECT NUMBER: DAA707176_C6_04	ARE BASED ON THE RECOMMENDATIONS OUTLINED IN THE	IGN	IBC GENERAL NOTES	0.
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CUSTOMER: AT&T MOBILITY		A-1	MODIFICATION PROFILE	0
		A-2	MONOPOLE EXTENSION INSTALLATION DETAILS	0
CUSTOMER SITE NAME: WILOX AND COLLEGE/DNVRC03588		F-1	MONOPOLE EXTENSION WELDMENT FABRICATION DETAILS	. 0
		F-1A	MONOPOLE EXTENSION WELDMENT FABRICATION DETAILS (CONT'D).	
CUSTOMER SITE NUMBER: COL03088 / 10127031		CP21BC	CAP PLATE FABRICATION DETAILS	
1314 RED CEDAR CIRCLE				1
SITE ADDRESS: FORT COLLINS, CO 80524		-		
DATE: 02/09/18				
GEOGRAPHIC COORDINATES: 40.60488056 -105.07416389				

TOWER	entrant :		O, e.u.n	
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					WATERIA				
AMERICANTO	NOTES	WEIGHT (lb)	PART	SHEET LIST	LENGTH	DESCRIPTION	PART NUMBER	PROVIDED	
ATC TOWER SERVICE						EXTENSION MATERIAL & HARDWARE			
3600 REGENCY PARKY		1035	1034.5	A-2, F-1, F-1A	10'-0"	18" OD PIPE EXTENSION WELDMENT	302435-1	T	of the second
SUITE 100 CARY, NC 27518 PHONE: (B18) 488-01		17	16.8	A-2 CP21BC	2.0	PL 1/8" X 24"	CP21BC	1	-1
- Camado Branco	HHN-LKW-FW / GALVANZED	-	-		3"	BOLT, 3/4*Ø ASTM A325	-	8	2
THESE CRAININGS AND OR THE ACCOMPANY	HHN / GALVANZED	-		160	4 1/2"	BOLT, 3/4"Ø ASTMA325		13	12
THESE ORANINGS AND OF THE ACCOMPANY AS INSTRUMENTS OR SERVICE ARE THE DIC OF AMPRICAN TOWER THEIR USE AND PAIR. RESTRICTED TO THE ORIGINAL SITE FOR WHI	GALVANIZED	Team (inest	(minut)	2440	FLAT WASHER 3/410 ASTM F436	- interior	13	12
PREPARED. ANY USE OR DISCLOSURE OTHER RELATED TO AMERICAN TOWER OR THE SPE	GALVANZED	-			-	DTI SQUIRTER WASHER 3/4"Ø (A 325 RATED)		13	12
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DISCREPANCIES ANY PRICE SISSANCE OF TI SUPERSESSED SYTHE LATEST MERCHON ON F TOWER	STANLESS STEEL		_		100:01	SAFETY CLIMB SYSTEM 3/B	-	-1	- 1
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302435									
ATC SITE NAME:					-				
JOSH AMES									
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1314 RED CEDAR CIRI FORT COLLINS, CO 60									
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B-1	PAGE 1 OF 1	1,052	IGHT (IE)	TOTAL WE					
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«MasTec **Network Solutions**

ANITA JEN 12/29/17 90% CDS DATE ANITA JEN 02/22/18 100% CDS DATE ANITA JEN 02/22/18 100% CDS WITH STRUCTURALS DATE 01/09/18 CONSTRUCTION DATE DATE SITE ACQUISITION

> PROJECT NAME MICROWAVE UPGRADE

SITE NAME WILCOX AND COLLEGE FA NUMBER

10127031

1314 RED CEDAR CIRCLE FORT COLLINS, COLORADO 80525

DRAWING DATES

12/27/17 90% CD REVIEW (P1-B1) 02/22/18 100% FINAL CDS (P1-B2)

SHEET TITLE

REFERENCE SHEET

GENERAL

ALL WORK SHALL BE DONE IN ADCORDANCE WITH LOCAL CODES AND OSKA SAFETY REGULATIONS.

ALL EXPOSED ISTRUCTURAL STEEL MEMBERS SHALL BE HIDT-DIPPED GALVANIZED AFTER FASRICATION PER ASTM A123 EXPOSED STEEL HARDWARE AND ANCHOR BOLTS SHALL BE GALVANIZED PER ASTM A153 OR 8595.

ALL U-BOLTS SHALL BE ASTW A36 OR EQUIVALENT, WITH LOCKING DEVICE, UMLESS NOTED OTHERWISE.

FIELD CUT EXCES, EXCEPT DRILLED HOLES, SHALL BE GROUND SMOOTH. ALL FIELD OUT SURFACES, FIELD DRILLED HOLES & CROUND SURFACES WHERE EXISTING FRANT OR CALLIANIZATION REMOVAL WAS REQUIRED SHALL BE REPARED WITH 13 JERUSHED COATS OF ZETO CAL VITTE COLD CALVAIRING COMPOUND FER ASTMARDS AND MANUFACTURES RECOMMENDATIONS.

ALL STRUCTURAL STEEL EMBEDDED IN THE COMPRETE SHALL BE APPLIED WITH (I BRUSHED COATS OF POCKBUARD CHIEF MASTIC OR BOUWLENT REFER TO THE MANUFACTURER SPECIFICATIONS FOR SURFACE PREPARATION AND APPLICATION AFFLICATION OF FOLYOURCE AND WAYER IN NOT ESSENTIAL.

ALL FIELD DRILLED HOLES TO BE USED FOR FIELD BOLTING INSTALLATION SHALL BE STANDARD HOLES, AS DEFINED BY ABC, UNLESS NOTED CTHERWASE.



WELDING

ALL VELDING TO BE PERFORMED BY AWS CERTIFIED WELDERS AND CONDUCTED IN ACCORDANCE WITH THE LATEST ECHTON OF THE AWS WELDING CODE D11.

ALL WELDS SHALL BE INSPECTED VISUALLY, IF DIRECTED BY ENGINEER OF RECORD, 25% OF WELDS SHALL BE INSPECTED WITH OVE PRINTERANT OR MAGNETIC PARTICLE. (100% IF REJECTABLE DEFEOTOR ARE FOLKIN) TO MEET THE ACCESTANCE CHITERIA OF AWAY DIT. SEPARA LL WELD AS INCRESSARY.

3. INSPECTION SHALL BE PERFORMED BY AN AWS CERTIFIED WELD INSPECTOR.

ALL SERCTRODES TO SELOW HYDROGEN, MATCHING PELER METAL, MER AWE DIE! UNLESS NOTED DT-PRIMISE.

PRIOR TO PELD WELDING GALVANCED MATERIAL CONTRACTOR SHALL DRING OFF GALVANDING V2* BEYOND ALL PIED WELD SUPFACES, AFTER WELD AND WELD INSPECTION IS COMPLETE, REPAIR ALL GROUND AND WELDER SUPFACES WITH DIS DAVILUTE DOLD GALVANDING SOMPOUND HER ASTRUATED AND MANUFACTURES RECOMMENDATIONS.

3 IN LIEU OF USING DTI SQUIRTER IMASHERS, FLANGE BOLTS MAY BE TIGHTENED USING AISC/ROSC TURNOR-THE-NUTI METHOD, PEDIOMA APPROVAL BY THE ENGINEER OF RECORD (BOR). TIGHTEN FLANGE BOLTS USING 1THE CHART BELOW.

APPLICABLE CODES AND STANDARDS

ANSIYTA STRUCTURAL STANDARDS FOR STEEL ANTENNA TOWERS AND ANTENNA SUPPORTING STRUCTURES, 222-5 EDITION.

2 SOVE INTERNATIONAL BUILDING CODE 3 AC 318: AMERICAN CONCRETE INSTITUTE, BUILDING CODE REQUIREMENTS FOR STRUCTURAL DONCARTE, 348, LATEST EDITION.

4. ORSI: CONCRETE REINFORCING STEEL INSTITUTE, MANUAL OF STANDARD PRACTICE, LATEST EDITION.

ABG: AMERICAN INSTITUTE OF STEEL CONSTRUCTION, MANUAL OF STEEL CONSTRUCTION, LATEST EDITION.

8. AMS: AMERICAN WELDING SQUETY DT. I. STRUCTURAL WELDING CODE LATEST EDITION


SPECIAL INSPECTION

COLORADO



ATC SITE NAME JOSH AMES

FIRST ISSUE COM 02/09

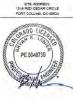

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MODIFICATION INSPECTION NOTES

THE SPECIAL INSPECTION ISIN PROCEDURES INTENDED TO CONFIRM THAT CONSTRUCTION AND INSTALLATION
MEET'S ENGINEERING DESIGN, ATC PROCEDURES AND ATC STANDARD SPECIFICATIONS FOR INFELESS TOWER
SITES.

SPECIAL INSPECTOR

THE SPECIAL INSPECTOR IS REQUIRED TO CONTACT THE GENERAL CONTRACTOR AS SOON AS RECEIVING A POPPOM ATC. UPON RECEIVING A POPPOM ATC THE SPECIAL INSPECTOR AT A MINIMUM MUST.

REVIEW THE REQUIREMENTS OF THE SI CHECKLIST

MORE IN THE RECOMMENDATION OF THE ST ORGANIZATION OF STREET, TO CONDUCT CHAIRTE INSPECTIONS, MORE WITH THE PRESENCE OF A SCHEDULE TO CONDUCT CHAIRTE INSPECTIONS, MOLECULAR CRUCKETON OF CONTROL THE ACCOUNT OF THE ACCOUNT OF CONTROL WASCESTELLY.

GENERAL CONTRACTOR

THE GENERAL CONTRACTOR IS REQUIRED TO CONTACT THE SI INSPECTOR AS SCION AS RECIMODIFICATION INSTALLATION OR TURNINEY PROJECT TO, AT A MINIMUM.

WORK WITH THE SI TO DEVELOP A SCHEDULE TO CONDUCT O MISTE INSPECTIONS, INCLUDING INSPECTIONS.

. BETTER UNDERSTAND ALL INSPECTION AND TESTING REQUIREMENTS. THE GENERAL CONTRACTOR SHALL PERFORM AND RECORD THE TEST AND WAS ACCORDANCE WITH THE REQUIREMENTS OF THE SI CHECKLIST.

SPECIAL INSPECTION CHECKLIST


INSPECTION DOCUMENT	DESCRIPTION	INSPECTION TESTING	RESPONSIBILITY	\$1 REVIEW REQUIRED			INSPECTION PREQUENCY		
MOTEOTION DOCUMENT	ACCOUNT TO M	REQUIRED	HELD CHESTER	PRECX	DURING CX	POST CX	PERIODIC	CONTINUOU	
SPECIAL INSPECTION FIELD WORK & REPORT	DOCUMENTATION AND SITE VISIT CONDUCTED BY AN ATC. APPROVID SPECIAL INSPECTOR AS REQUIRED BY ATC AND OTHER AUTHORITIES HAVING JURISDICTION. INSPECTION PARAMETERS TO FOLLOW ATC'S STANDARD SPECIFICATION FOR WIRELESS TOWER SITES.	•	SI SI	44					
ENGINEERING ASSEMBLY DRAWINGS	QC SHALL SUBMIT DRAWINGS TO SI FOR INCLUSION IN SI REPORT		00	~					
FABRICATED MATERIAL VERIFICATION & INSPECTION	TERIAL VERIFICATION & INSPECTION REPORTS TO BE INCLUDED IN SI REPORT WHEN REQUIRED BY ATC.		20	4					
CERTIFIED WELD INSPECTION	INSPECTION AND REPORT OF STRUCTURAL WELDING PERFORMED DURING PROJECT COMPLETED BY A CWI AND INCLUDED WITHIN SI REPORT		DD/TA						
FOUNDATION INSPECTION & VERBICATION	VIBUAL CREENVATION AND APPROVAL OF FOUNDATION EXCAVATION, RESAFFLACEMENT, CASINGSHORNG/PORMING FLACEMENT, AND ANNIHOR TRIBULATE AND MICHOR FLACEMENT - TO BE IS APPROVED PRIOR TO CONCRETE FOUR AND DOCUMENTED IN THE SIE REPORT.		- 1						
MICHOR, ROOM ANOHOR OR HELICAL PULL-OUTTEST	FULL TESTING OF INSTALLED ANCHORS TO BE COMPLETED AND DOCUMENTED IN SI REPORT		GC/TA				h		
CONCRETE INSPECTION & VERIFICATION	CONCRETE MIX DESIGN, SLUMP TEST, COMPRESSIVE TESTING, AND SAMPLE (SATHERING TECHNIQUES ARE TO BE PROVIDED FOR INCLUSION IN THE SI REPORT, SI SHALL MISRIFY CONCRETE PLACEMENT AS REQUIRED BY THE DEBICH COCUMENTS INSPECTION PREQUENCY MAKED CONTINUOUS).		GC /TA	1			li = = i		
DYWIDAG PLACEMENT ANCHOR BOLT EMBEDMENT - RPOXYGROUT INSTALL	ANCHORIBAR EMBEDMENT, HOLE SIZE, EPOXY/CROUT TYPE, INSTALLATION TEMPERATURE AND INSTALLATION SHALL BE VERIFIED BY THE SI AND INCLUDED IN THE SI REPORT		.00/81						
BASE PLATE GROUT INSPECTION & VERIFICATION	BASE PLATE DIROUTING TYPE AND PLACEMENT SHALL SE CONFIRMED BY THE STAND INCLUDED IN THE STREPORT		DIC/81						
EARTHWORK INSPECTION & VERIFICATION	EXCAVATION, FILL, SLOPE, GRADE AND OTHER EARTHWORK REQUIREMENTS PER PLANS SHALL SE VERIFED BY THE SLAND, INCLUDED IN THE SLREPORT.		OC/TA						
COMPACTION VERIFICATION	CONTRACTOR SHALL PROVIDE AN INDEPENDENT THRO PARTY CIERTIFIED INSPECTION WHICH PROVIDES TEST RESULTS FOR COMPACTION TEST OF SOILS IN PLACE TO ASTINISTANDARDS.		BS/TA] [
OROUND TESTING & VERIFICATION	OC SHALL PROVIDE DISCURENTATION SHOWING THAT THE GROUNDING SYSTEM SHALL HAVE A MEASURED RESISTANCE TO THE GROUND OF MOT MORE THAN THE RECOMMENDED TO DIME. STATE AT DE OWNSTRUCTION SPECIFICATION LINCER. SECTION 2 15 THIS DOCUMENTATION MUST SHE WINDERSONED CERTIFICATION.		60						
STEEL CONSTRUCTION INSPECTION & VERIFICATION	VISIAL DISSERVATION AND APPROVAL OF STEEL CONSTRUCTION TO SE PERFORMED BY THE SIL INSPECTION TO INCLUDE VERRICATION OF NEW CONSTRUCTION OR INCOMPLICATION OF EMISTING CONSTRUCTION FER ENGINEERED PLANS. DETAILED VERFICATION SHALL SIL MILLIONED IN SIL REPORT.		86			v	4		
ON-SITE COLD GALVANIZING VERIFICATION	SI SHALL VERIFY WITH DC ALL COLD GALVANIZATION TYPE AND APPLICATION AND INCLUDE SUMMARY IN SI REPORT	*	GC			4	4		
OUY WIRE TENSIONING & TOWER ALIGNMENT REPORT	GC SHALL PROVIDE SI EVIDENCE OF PROPER GUY TENSIONING AND TOWER PLUMS PER PLANS. SI SHALL VERIFY AND INCLUDE PLUMB AND TENSION REPORTING IN SI REPORT.		GC.				. 21		
GC AS-BUILT DRAWINGS WITH CONSTRUCTION RED-LINES	GC SHALL SUBMIT "AD-BULL" DRAWINGS INDICATING ANY APPROVED CHANGES TO ENGINEERED PLANS TO SI FOR APPROVAL REVIEW AND INCLUSION IN SI REPORT.	•	00			4			
SI AS-BULT DRAWINGS WITH INSPECTION RED-LINES (AS REQUIRED)	SESHALL SUBMIT AS-BUILT DRAWINGS INDICATING ANY APPROVED CHANGES TO ENGINEERED PLANE WITHIN SEREPORT	4	83			~			
TIA INSPECTION	SI SHALL COMPLETE TIA INSPECTION AND PROVIDE SEPARATE TIA INSPECTION DOCUMENTATION TO ATC CM	11	SI			100			
PHOTOGRAPHS	PHOTOGRAPHIC EVIDENCE OF SPECIAL INSPECTION, ON SITE REMEDIATION, AND ITEMS FALLING INSPECTION & REQUIRING FOLLOW UP TO BE INCLUDED WITHIN THE SI REPORT. COMPLETE PHOTO LOG IS TO BE SUBMITTED WITHIN SI REPORT.	*	GC/SI			4			


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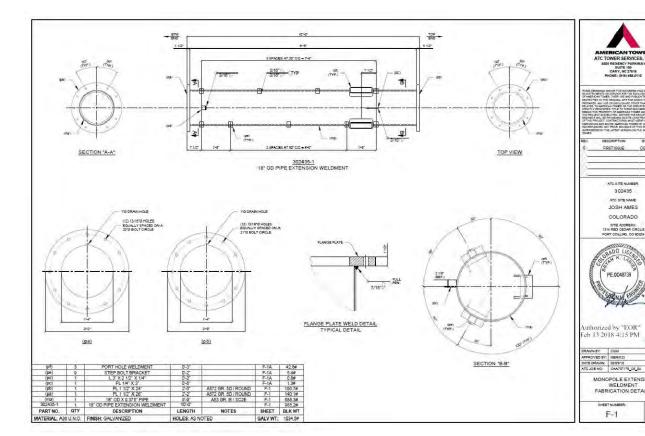
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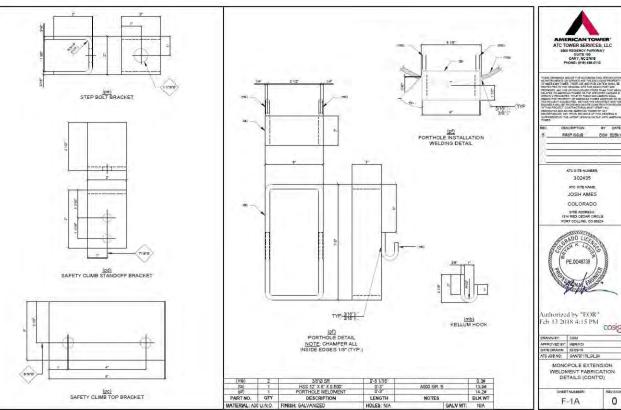
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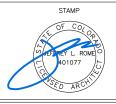
Jeffrey Rome | ASSOCIATES

architecture | telecommunications

131 Innovation Drive; Suite 100 Irvine, California 92617 tel 949.760.3929 | fax 949.760.3931

PROPRIETARY INFORMATION

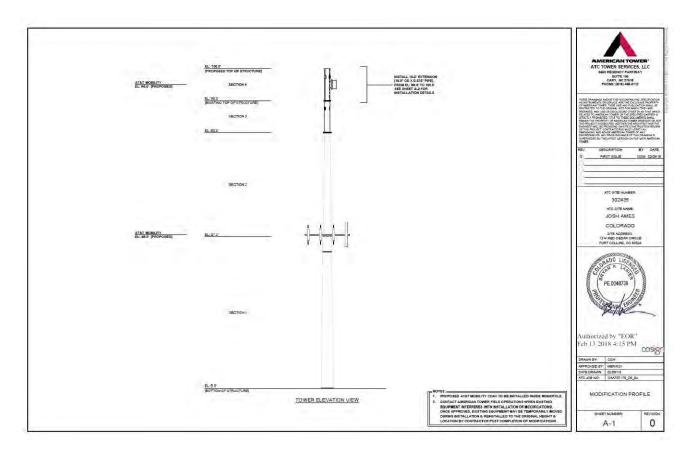THE INFORMATION CONTAINED IN THIS SET OF CONSTRUCTION DOCUMENTS IS PROPRIETARY BY NATURE. ANY USE OR DISCLOSURE OTHER THAN THAT WHICH RELATES TO AT&T WIRELESS IS STRICTLY PROHIBITED.

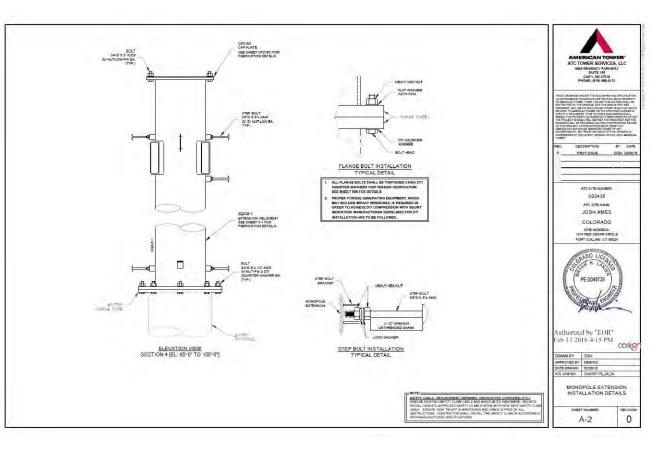

PREPARED FOR

«MasTec **Network Solutions**

APPROVALS ANITA JEN 12/29/17 90% CDS DATE ANITA JEN 02/22/18 DATE 100% CDS ANITA JEN 02/22/18 100% CDS WITH STRUCTURALS DATE CHRISTINA MICHAUD 01/09/18 CONSTRUCTION DATE DATE SITE ACQUISITION

> PROJECT NAME MICROWAVE UPGRADE

> > SITE NAME

WILCOX AND COLLEGE FA NUMBER

10127031 1314 RED CEDAR CIRCLE FORT COLLINS, COLORADO 80525

DRAWING DATES


12/27/17 90% CD REVIEW (P1-B1) 02/22/18 100% FINAL CDS (P1-B2)

SHEET TITLE

REFERENCE SHEET

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REF-2



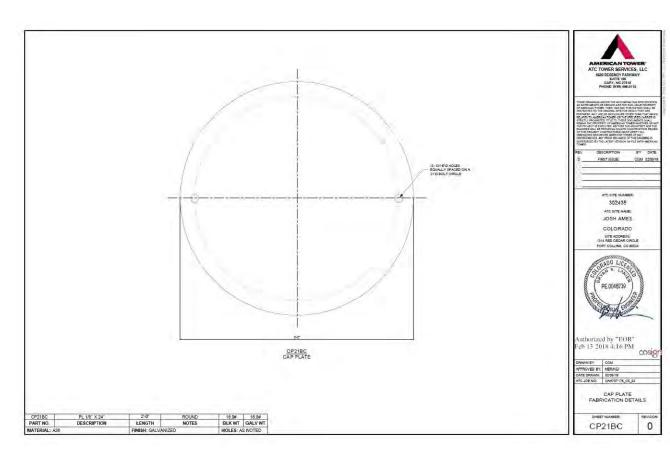

Jeffrey Rome | ASSOCIATES

architecture | telecommunications

131 Innovation Drive; Sulte 100 Irvine, California 92617 tel 949.760.3929 | fax 949.760.3931

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APPROVALS	
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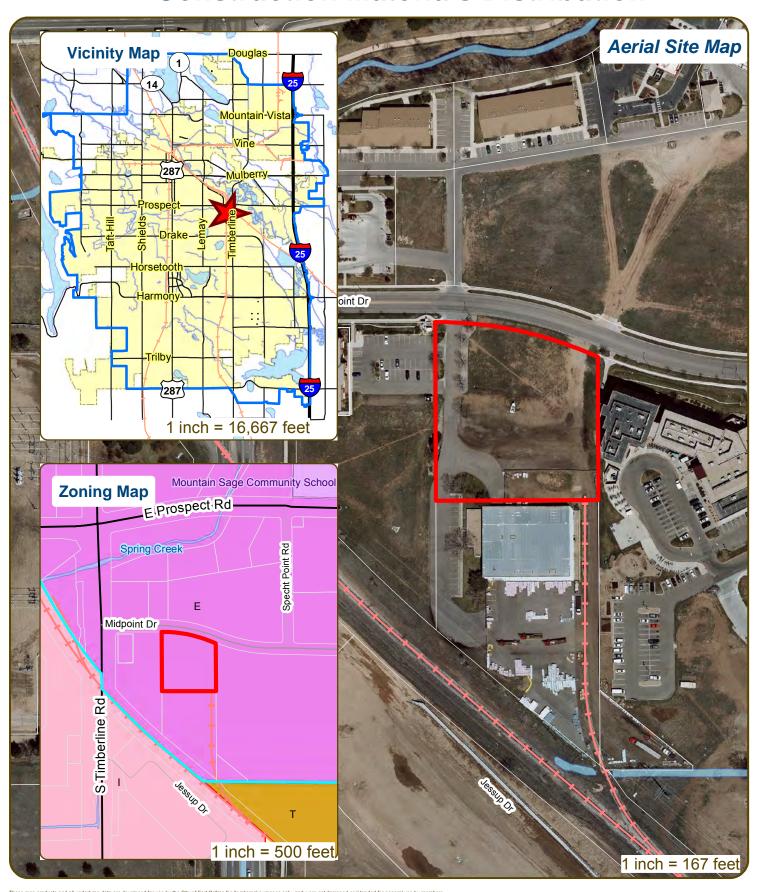
12/27/17 90% CD REVIEW (P1-B1) 02/22/18 100% FINAL CDS (P1-B2)

SHEET TITLE

REFERENCE SHEET

REF-3

2155 Midpoint Dr Construction Materials Distribution



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CONCEPTUAL REVIEW: **APPLICATION**

General Information


All proposed development projects begin with Conceptual Review. Anyone with a development idea can schedule a Conceptual Review meeting to get feedback on prospective development ideas. At this stage, the development idea does not need to be finalized or professionally presented. However, a sketch plan and this application must be submitted to City Staff prior to the Conceptual Review meeting. The more information you are able to provide, the better feedback you are likely to get from the meeting. Please be aware that any information submitted may be considered a public record, available for review by anyone who requests it, including the media.

Conceptual Reviews are scheduled on three Monday mornings per month on a "first come, first served" basis. One 45 meeting is allocated per applicant and only three conceptual reviews are done each Monday morning. Conceptual Review is a free service. Complete applications and sketch plans must be submitted to City Staff no later than 5 pm, two Tuesdays prior to the meeting date. Application materials must be e-mailed to currentplanning@fcgov.com. If you do not have access to e-mail, other accommodations can be made upon request.


At Conceptual Review, you will meet with Staff from a number of City departments, such as Community Development and Neighborhood Services (Zoning, Current Planning, and Development Review Engineering), Light and Power, Stormwater, Water/Waste Water, Advance Planning (Long Range Planning and Transportation Planning) and Poudre Fire Authority. Comments are offered by staff to assist you in preparing the detailed components of the project application. There is no approval or denial of development proposals associated with Conceptual Review. At the meeting you will be presented with a letter from staff, summarizing comments on your proposal.

BOLDED ITEMS ARE REQUIRED *The more info provided, the more detailed your comments from staff will be.* Contact Name(s) and Role(s) (Please identify whether Consultant or Owner, etc)
Deanne Frederickson, Consultant, For Dohn Construction / Allied Building
Business Name (if applicable) Baseline Engineering
Your Mailing Address 1950 Ford Street, Golden, Colorado 80401
Phone Number 970 534 9095 Email Address deanne.frederickson@baselinecorp.com
Site Address or Description (parcel # if no address) 2155 Midpoint Drive, FC, 80525
Description of Proposal (attach additional sheets if necessary) Develop lot to include 165 \times 40 Lein-To (open on one side) structure and yard for distribution
of roofing materials. Trips include 20-25 employees / 20 daily deliveries
Proposed Use <u>Materials Distribution</u> Existing Use <u>Vacant Lot</u>
Total Building Square Footage $\underline{6,600}$ S.F. Number of Stories $\underline{1}$ Lot Dimensions $\underline{281 \times 284}$
Age of any Existing Structures no existing structures on the site Info available on Larimer County's Website: http://www.co.larimer.co.us/assessor/query/search.cfm If any structures are 50+ years old, good quality, color photos of all sides of the structure are required for conceptual.
Is your property in a Flood Plain? ☐ Yes ☒ No ☐ If yes, then at what risk is it? ☐ Info available on FC Maps: http://gisweb.fcgov.com/redirect/default.aspx?layerTheme=Floodplains .
Increase in Impervious Area $\underline{60,685}$ SF S.F. (Approximate amount of additional building, pavement, or etc. that will cover existing bare ground to be added to the site)
Suggested items for the Sketch Plan:

Property location and boundaries, surrounding land uses, proposed use(s), existing and proposed improvements (buildings, landscaping, parking/drive areas, water treatment/detention, drainage), existing natural features (water bodies, wetlands, large trees, wildlife, canals, irrigation ditches), utility line locations (if known), photographs (helpful but not required). Things to consider when making a proposal: How does the site drain now? Will it change? If so, what will change?

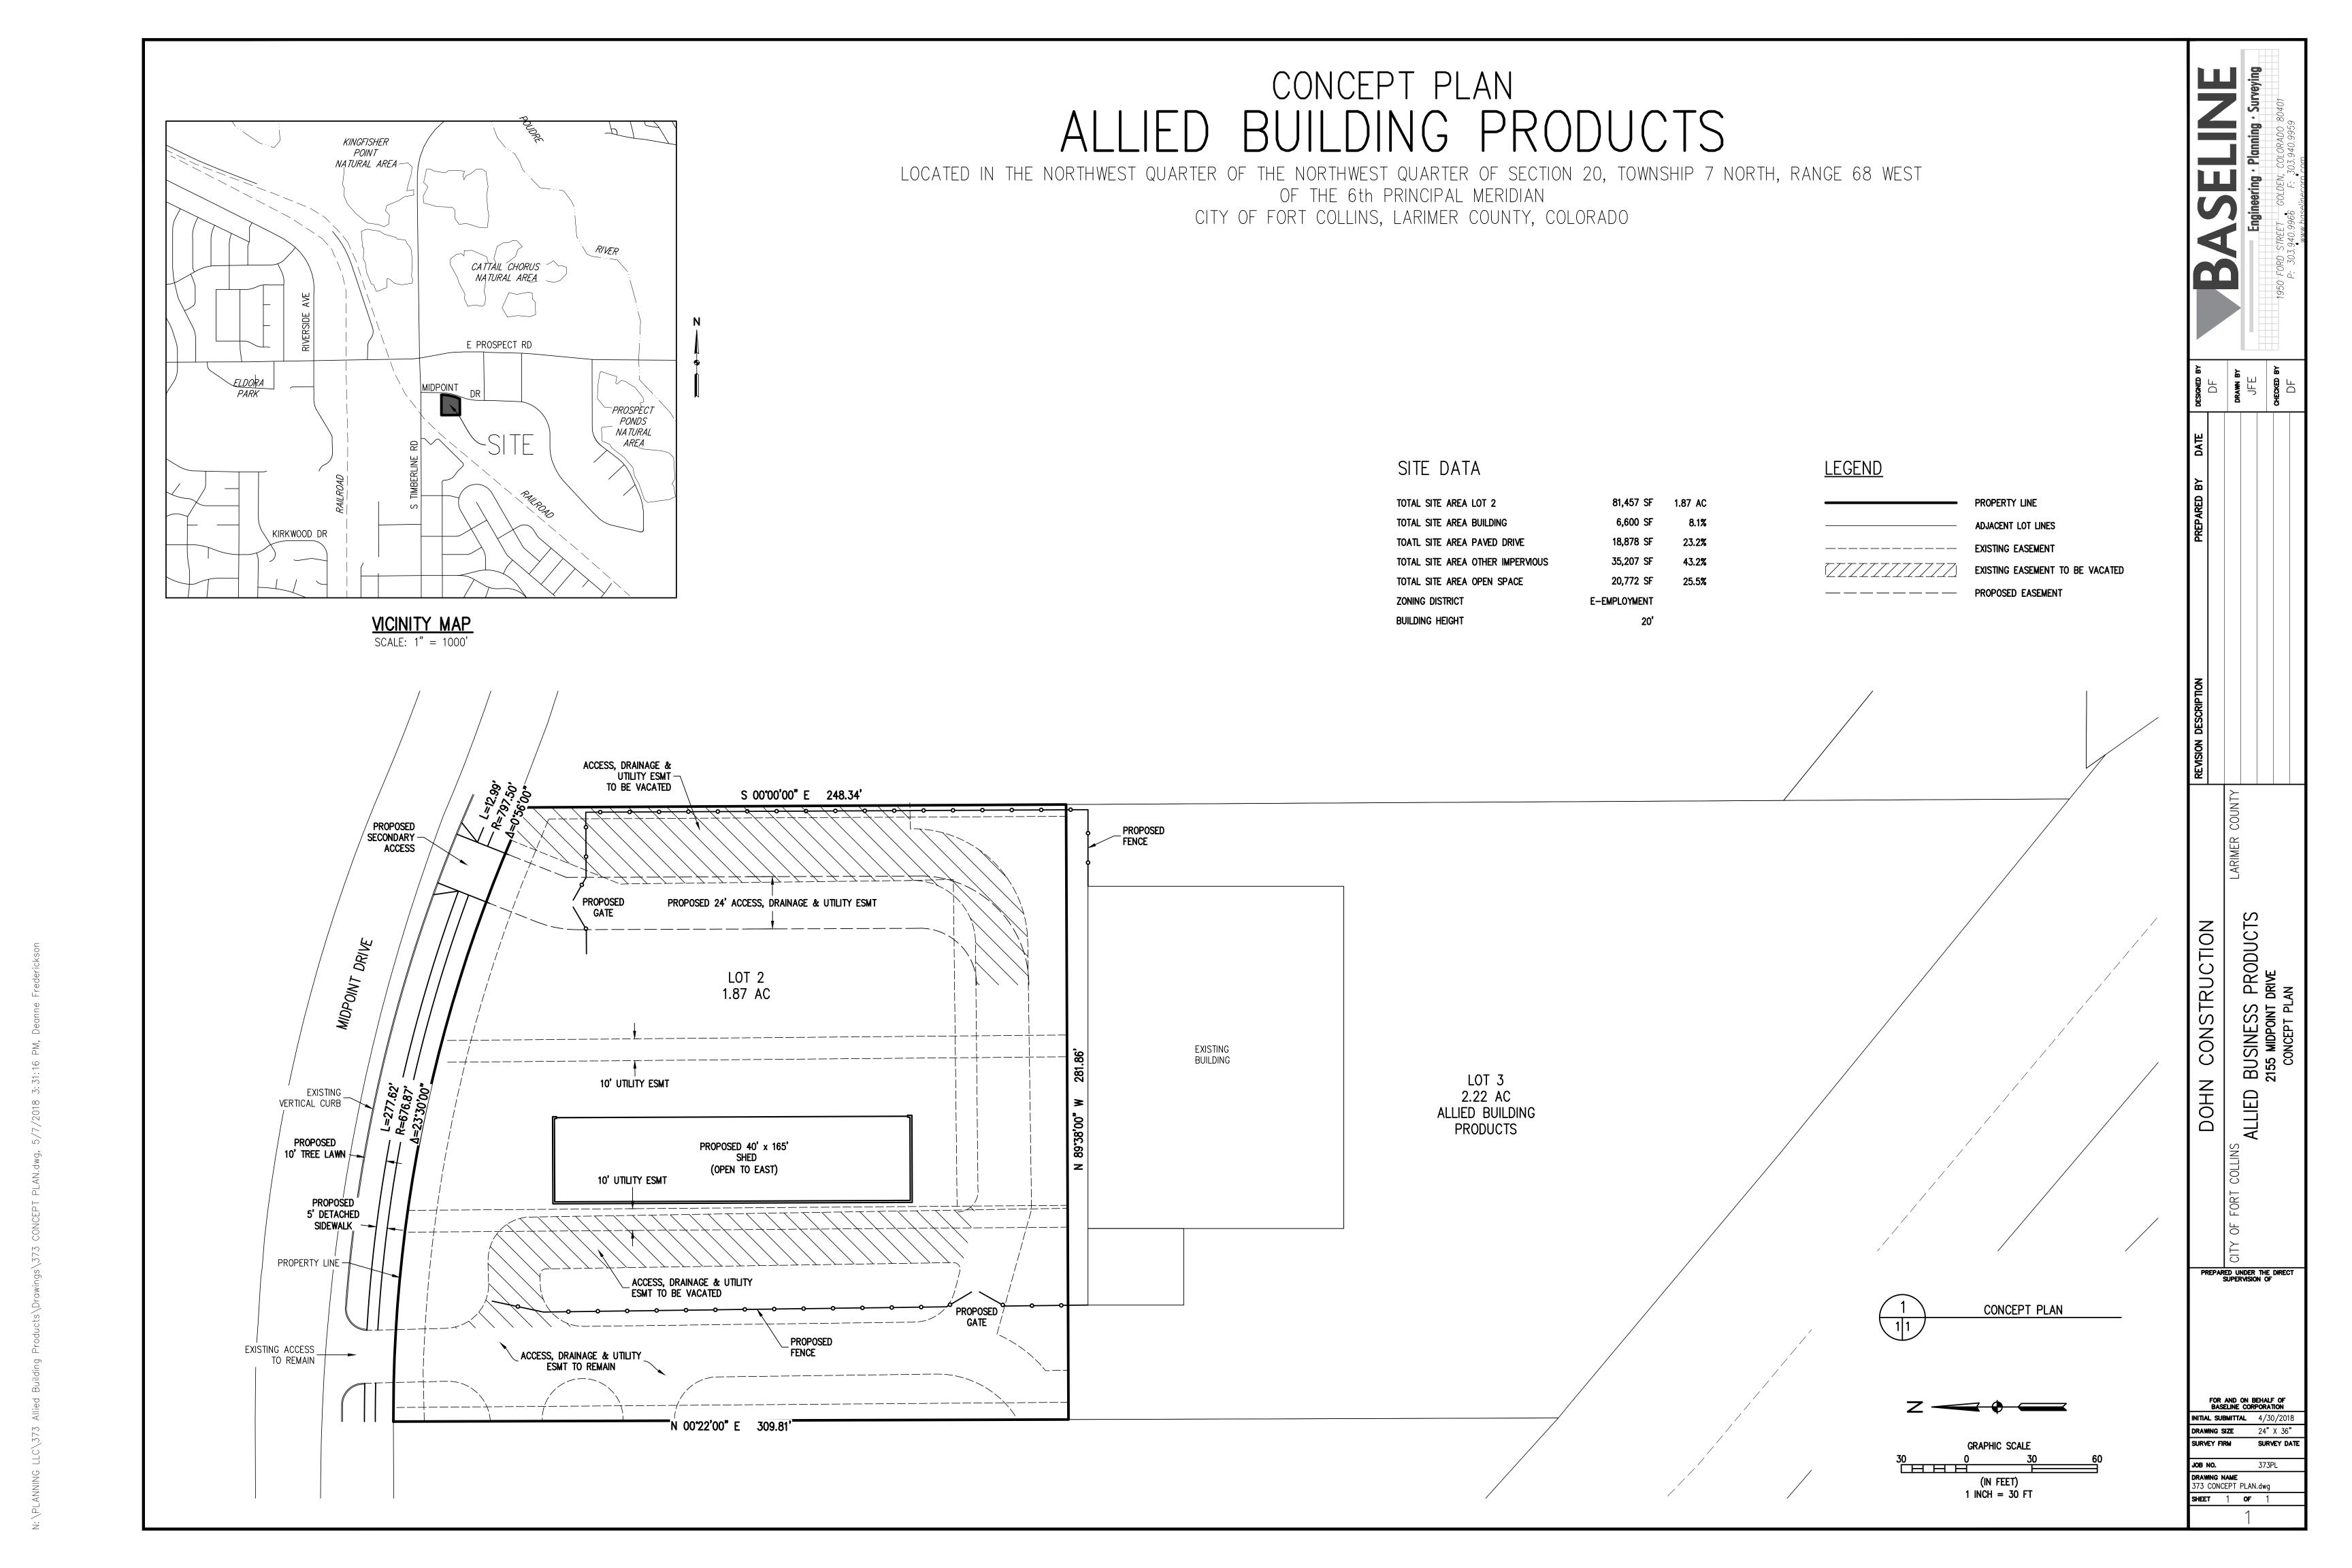

748 N College Ave OTAC CrossFit

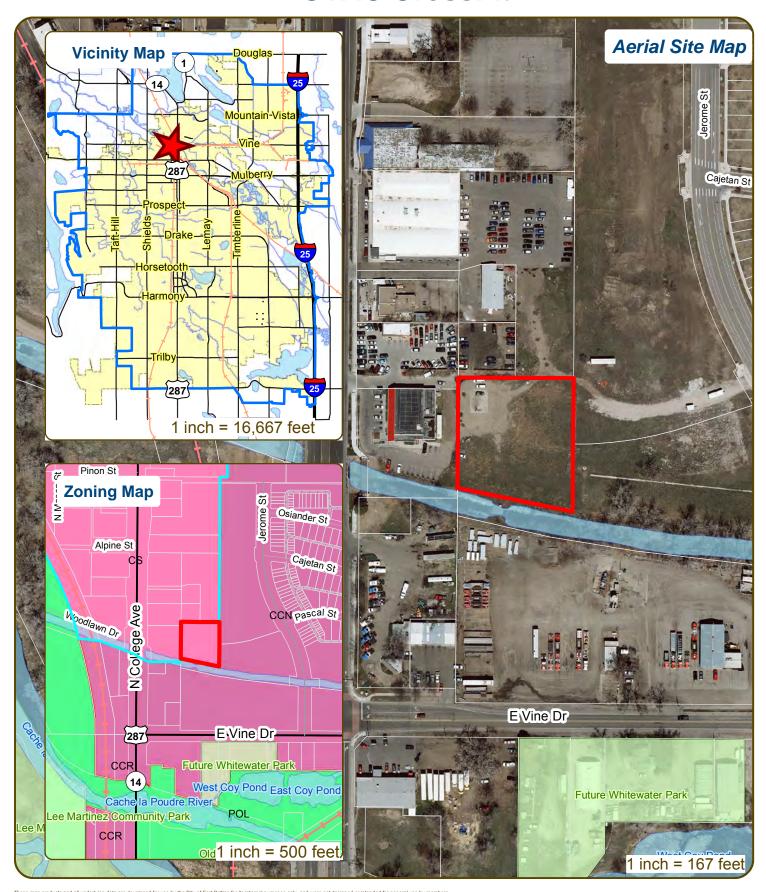

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Development Review Guide – STEP 2 of 8 CONCEPTUAL REVIEW:

APPLICATION

General Information

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Contact Name(s) and Role(s) (Please identify when the contact Name(s) (Please identify identify when the contact Name(s) (Please identify identify identify identify identify identify identify identify identified identification (Please identified identify identified	nether Consultant, Owner, etc	2.)
Business Name (if applicable)		
Mailing Address		
Phone	Email Address	
Site Address (parcel # if address in not available)		
Description of Proposal (attach additional sheets	s if necessary)	
Proposed Use	Existing Use	
Total Building Square Footage	Number of Stories	Lot Dimensions
Age of any Existing Structures		
nfo available on Larimer County's Website: http://w	ww.co.larimer.co.us/assesso	r/query/search.cfm
f any structures are 50+ years old, good quality, co	lor photos of all sides of the s	tructure are required for conceptual.
s your property in a Flood Plain? ☐ Yes ☐ No	If yes, then at wh	at risk isit?
nfo available on FC Maps: http://gisweb.fcgov.com/	<u>/redirect/default.aspx?layerTh</u>	eme=Floodplains.
ncrease in Impervious Area		S.F.
Approximate amount of additional building, pavement	ent. or etc. that will cover exis	ting bare ground to be added to the site)

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BIKE PORKING - 4 MIN. - NEED TO BEXISTING UTILITY EASTER ENTENT PORKING - 21 (1 H.c., van-access.)

PERKING - 21 (1 H.c., van-access.)

